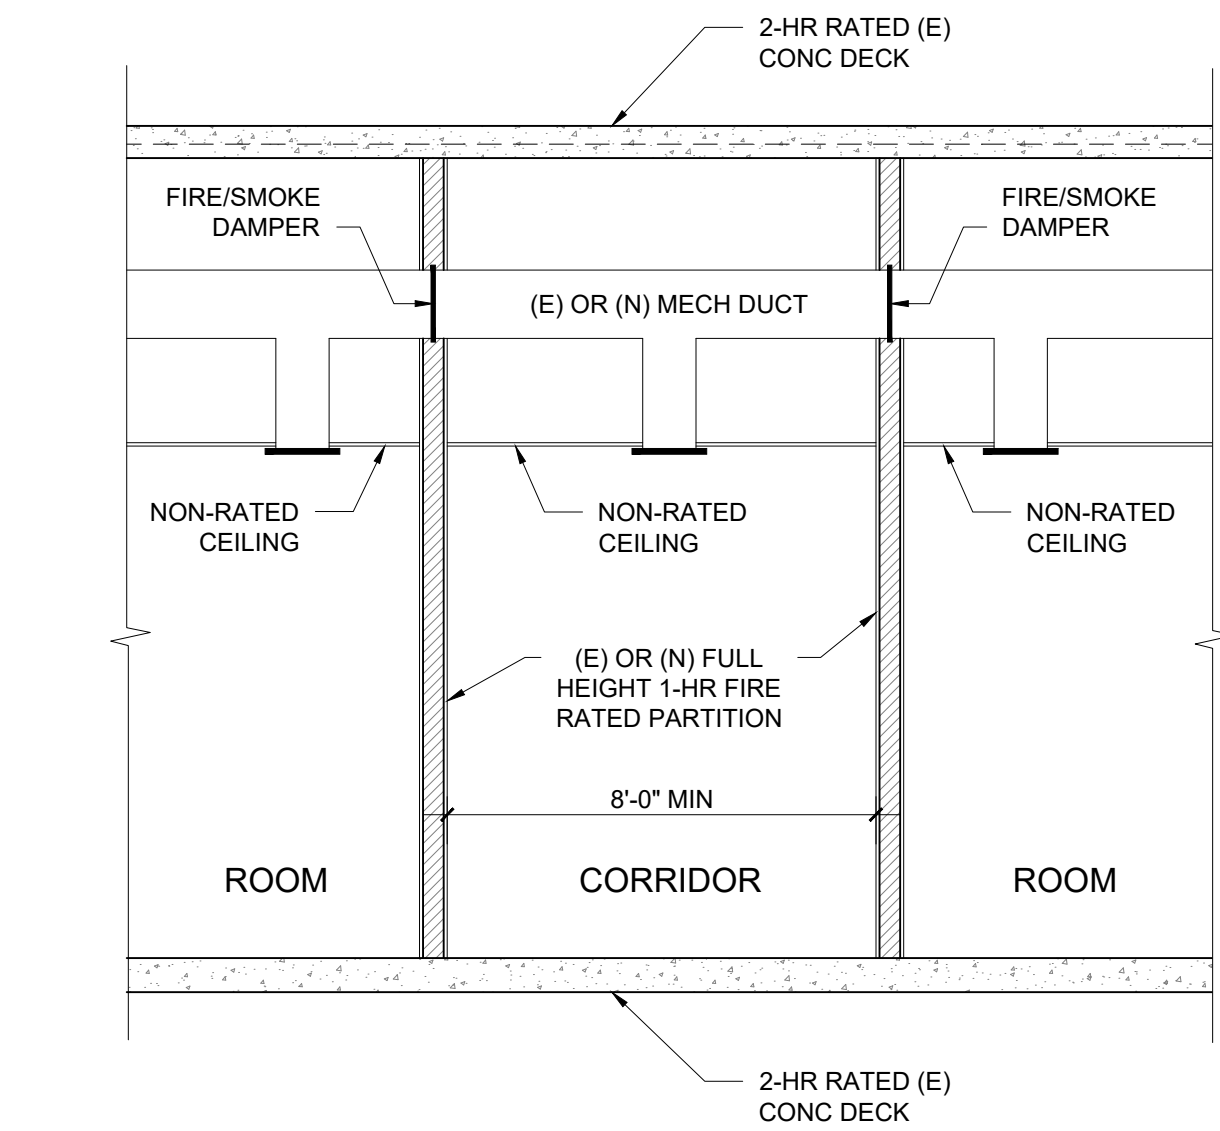


LEGEND:

- (E) TECHNOLOGY ROOM WITH (E) SECURITY EQUIPMENT NOTE: NO NEW EQUIPMENT
- (E) INTERIOR EXIT STAIRWAY OR SHAFT ENCLOSURE WITH 2-HR FIRE BARRIER PER CBC 707.3.1, 707.3.2, 713, 1023.2 AND 1024.3
- (E) CORRIDOR WITH 1-HR FIRE PARTITION PER CBC 708
- (E) SMOKE BARRIER PER CBC 707
- (E) 1-HR FIRE BARRIER PER CBC 707
- (E) 2-HR FIRE BARRIER PER CBC 707
- (E) 4-HR FIRE BARRIER PER CBC 707
- (E) 1-HR FIRE RATED PARTITION PER CBC 708
- (E) HORIZONTAL EXIT DESIGNATION
- (E) EXIT @ GRADE
- (E) EXIT

FLS PLAN KEYNOTES:

- EXIT DISCHARGE AT GRADE 1 LEVEL DOWN ON LEVEL 3
- EXIT DISCHARGE AT GRADE 2 LEVELS DOWN ON LEVEL 2
- EXIT DISCHARGE AT GRADE 3 LEVELS DOWN ON LEVEL 1



Consultant

SKA Project Number

2219

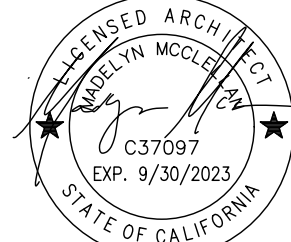
HCAI Number

S221127-38-00

HCAI seal/signature



Seal/Signature



Issued for

HCAI PLAN REVIEW

Drawn by

JS

Checked by

CL

Project Name

4TH FLOOR ACU
AUTOMATIC DOOR
OPERATORS

Sheet Title

LEVEL 4 FIRE & LIFE
SAFETY PLAN

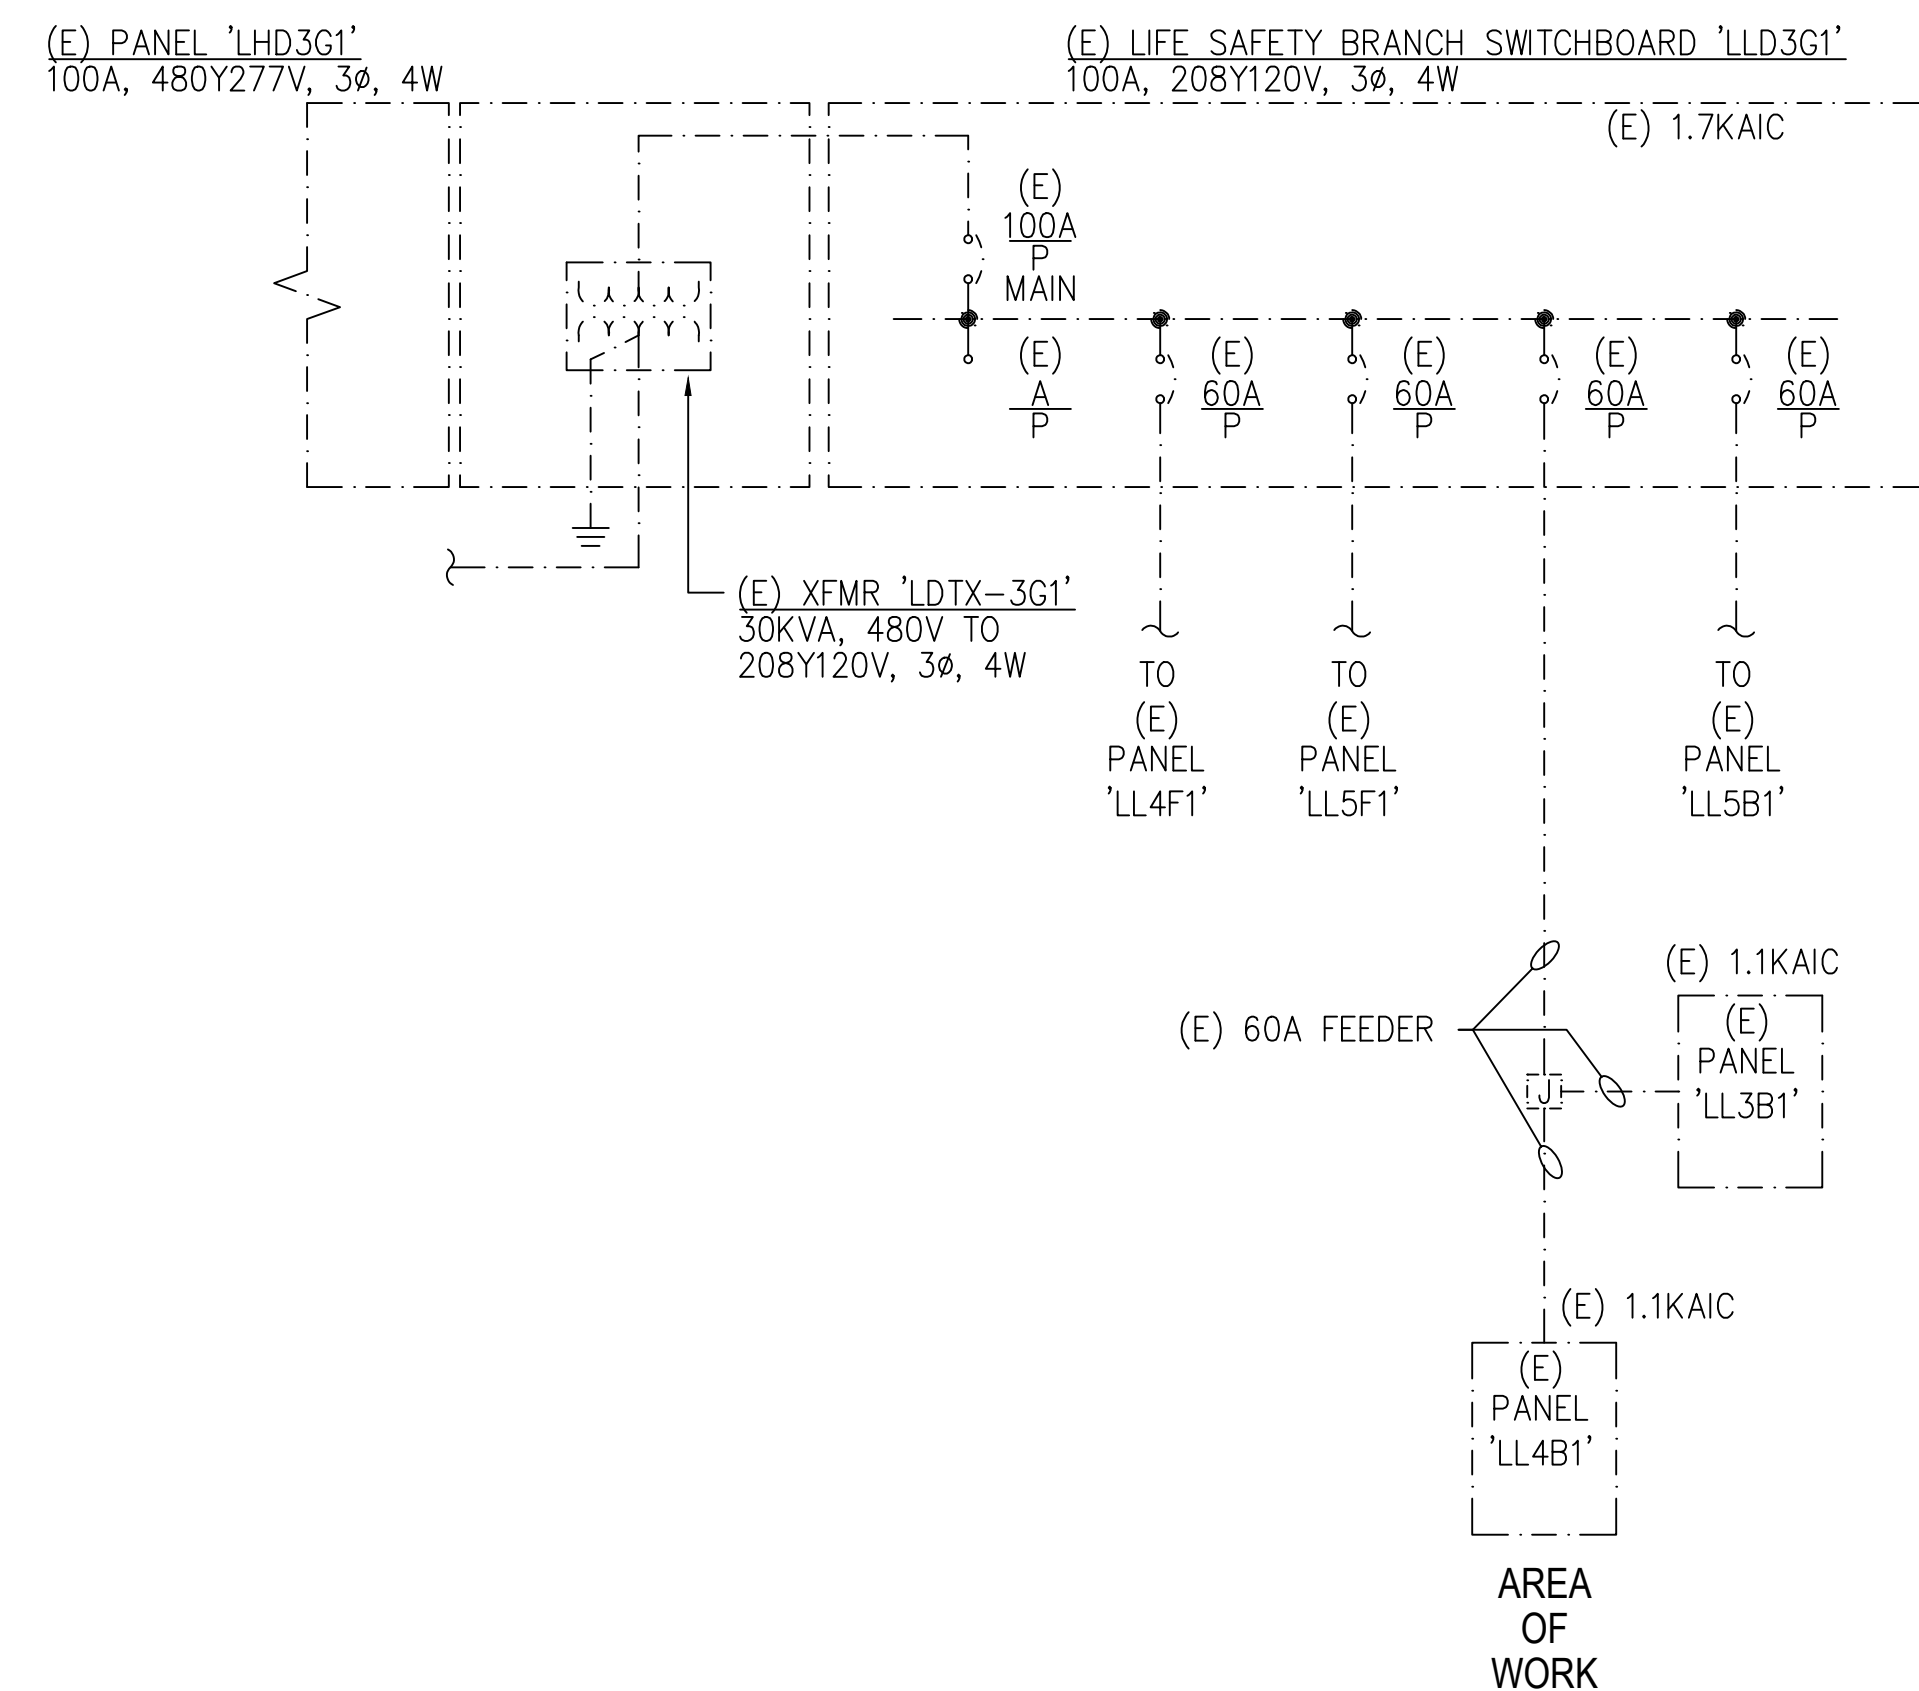
Date

07/06/2022

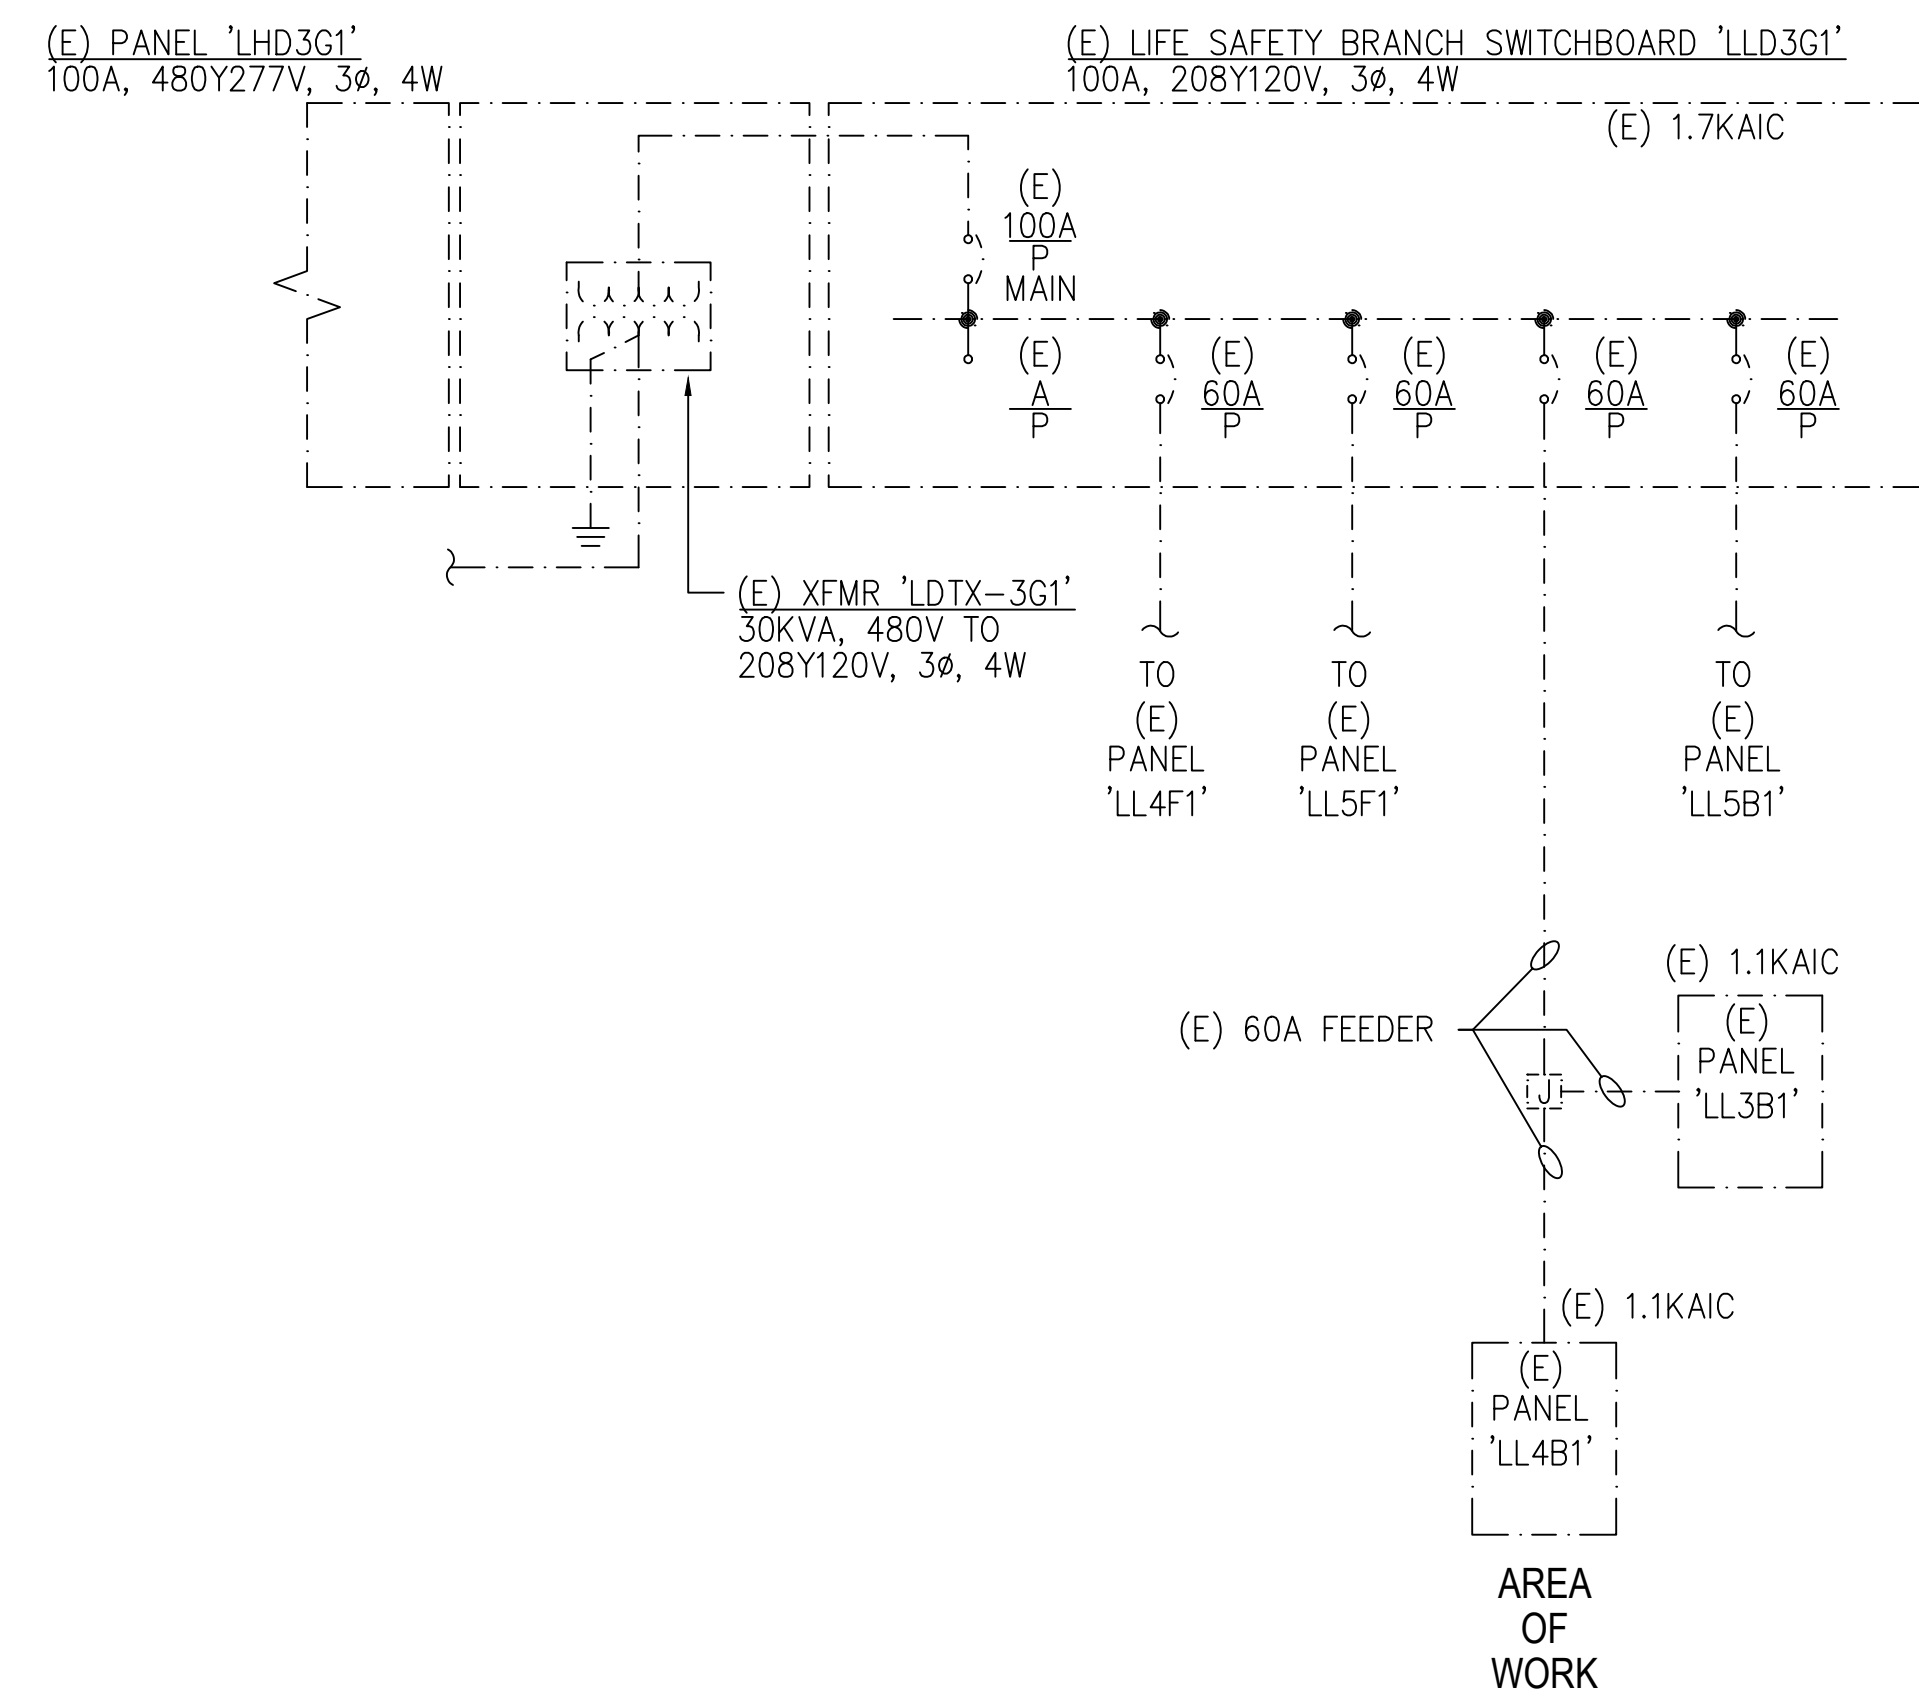
Scale

AS NOTED

Sheet Number



- 1 CONNECT NEW LS BR CIRCUIT TO SPARE 20A/1P BREAKER #11. RUN NEW LS BR CIRCUIT THROUGH NEW FA RELAY AT EACH DOOR OPENER. SEE FA DRAWINGS.
- 2 DOOR C491-A: CARD READER TO RELEASE AND ACTIVATE DOOR OPENER WITHOUT DELAY ACTION. DELAY ACTION ON THE PANIC DEVICE IS EXISTING FUNCTION TO REMAIN.
- 3 DISCONNECT (E) EQUIPMENT BR 20A,120V CIRCUIT QL4B1-5 TO DELAY ACTION, PROVIDE CONTINUED OPERATION OF CIRCUIT TO REMAINDER OF DOORS.



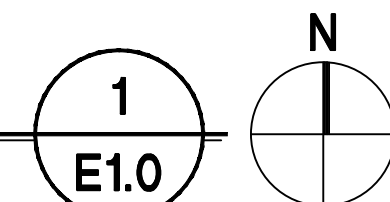
SCALE: NONE

(E) LIFE SAFETY BRANCH PANEL 'LL481'												
MAN: 60A CB			120/208V, 3 Ph, 4W,						FED FROM: SWBD LLD3G1 VA SB			
MFCR: Eaton, Type: PRL1A									SURFACE MOUNTED			
LOC: ELEC RM 4181 (4906)			60 AMP BUS			10K ISC			NEMA 1			
DESCRIPTION		KVA	BKR	CKT	Ph A	Ph B	Ph C	CKT	BKR	KVA	DESCRIPTION	
SPARE			201	1				2	201		SPARE	
SPARE			201	3				4	201		SPARE	
SPARE			201	5				6	201		SPARE	
(E) MGA PNL 4603,4128,4114	0.43	201	7	0.43				8	201		SPARE	
(E) AUTO DOORS C4111,C4113,C4114	1.01	201	9		1.01			10	201		SPARE	
(N) AUTO DOORS *	0.72	201	11			0.72		12	201		SPARE	
SPARE			201	13				14	201		SPARE	
SPARE			201	15				16	201		SPARE	
SPARE			201	17				18	201		SPARE	
SUBTOTAL:					0.4	1.0	0.7					
CONNECTED LOAD		2.2 KVA									* CONNECT TO SPARE BREAKER SHOWN	
TOTAL LOAD		2.2 KVA / 0.360 FACTOR =		6 AMPS		60 AMP FEEDER IS ADEQUATE						

(E) PANEL LL4B1: LOAD SUMMARY WITH ADDED LOAD = 2.2 KVA
(E) PANEL LL3B1: LOAD SUMMARY = 1.9 KVA
TOTAL REVISED LOAD = 4.1 KVA
11.4 AMPS ON 60AMP FEEDER

60AMP FEEDER IS ADEQUATE FOR ADDED LOAD

SCALE: 1/4" = 1'-0"

[illegible]

Sheet Number

Fire Alarm System Tenant Improvement

CALIFORNIA PACIFIC MEDICAL CENTER CATHEDRAL HILL HOSPITAL 4TH FLOOR ACU AUTOMATIC DOOR OPERATORS ADDITION

VAN NESS AND GEARY CAMPUS SAN FRANCISCO, CA

PROJECT INFORMATION
BUILDING OWNER SUTTER HEALTH 2280 GATEWAY OAKS DRIVE, SUITE 220 SACRAMENTO, CA 95833
AUTOMATIC SPRINKLER SYSTEM FULLY SPRINKLERED BUILDING
CONSTRUCTION CLASSIFICATION TYPE 1-A FIRE RESISTIVE
BUILDING OCCUPANCY PRIMARY CARE HOSPITAL - GROUP I-2 OCCUPANCY FOR ALL TREATMENT AND NURSING LEVELS 1-10
BELOW-GRADE PARKING - GROUP S-2 OCCUPANCY FOR LEVELS P1, P2 AND P3
PUBLIC, OFFICE AND SUPPORT SPACES - GROUP B OCCUPANCY FOR LEVELS 1, 2 AND 11
LARGE DINING AREA - GROUP A-2 OCCUPANCY
LARGE CONFERENCE ASSEMBLIES - GROUP A-3 OCCUPANCY
CENTRAL PLANT AND OTHER MAIN MECHANICAL AND ELECTRICAL ROOMS - GROUP F-2 OCCUPANCY
CENTRAL STATION
MONITORING INFORMATION RAPID RESPONSE MONITORING SERVICES 400 E RINCON CORONA, CA 92879 (800) 935-3822 UIUF S3282-3
ALARM SERVICE COMPANY CONVERGINT TECHNOLOGIES 5860 WEST LAS POSITAS DRIVE, SUITE 7 PLEASANTON, CA. 94588 (510) 300-2800

SCOPE OF WORK
THE SCOPE OF WORK IS TO PROVIDE SEVERAL AUTOMATIC DOOR OPERATORS IN VARIOUS LOCATIONS THROUGHOUT THE EXISTING CATHEDRAL HILL HOSPITAL. THE FIRE ALARM SYSTEM WILL INCLUDE THE FOLLOWING:
1. ADDING AUTOMATIC DOOR OPERATORS PER DOOR SCHEDULE LIST AS SPECIFIED ON SHEET FA.003

GENERAL NOTES
1. ALL DEVICE LOCATIONS, WIRING, CONDUITS SHOWN ON DRAWINGS ARE SUBJECT TO FIELD VERIFICATION. ANY DEVIATION MUST BE APPROVED BY THE FIRE ALARM CONTRACTOR AND MUST COMPLY WITH THE NATIONAL AND LOCAL CODES LISTED ON THIS SHEET.
2. 120VAC PRIMARY POWER SOURCE TO FIRE ALARM PANELS AND POWER SUPPLIES MUST BE ON A MECHANICALLY PROTECTED DEDICATED BRANCH CIRCUIT WITH DISCONNECTING MEANS PERMANENTLY IDENTIFIED AT THE CONTROL UNIT. DISCONNECTING MEANS TO BE IDENTIFIED AS "FIRE ALARM CIRCUIT" IN RED MARKING AND ACCESSIBLE ONLY TO AN AUTHORIZED PERSONNEL.
3. 120VAC AND FIRE ALARM CIRCUITS MUST MAINTAIN A 1/4" SEPARATION. NEVER RUN IN SAME RACEWAY.
4. AFTER COMPLETION OF WORK, ELECTRICAL CONTRACTOR MUST PROVIDE TO THE FIRE ALARM CONTRACTOR A COMPLETE SET OF "RECORD DRAWINGS" SHOWING ALL DEVICE LOCATIONS, DEVICE ADDRESSES, CIRCUIT NUMBERS AND WIRING (IF APPLICABLE).
5. SEE DETAIL SHEETS FOR DEVICE MOUNTING HEIGHTS AND INSTALLATION INFORMATION. ANY DEVIATION MUST BE APPROVED BY THE FIRE ALARM CONTRACTOR AND MUST COMPLY WITH THE NATIONAL AND LOCAL CODES LISTED ON THIS SHEET.
6. BACKBOXES, JUNCTION BOXES AND TERMINAL CABINETS TO BE PROVIDED BY THE ELECTRICAL CONTRACTOR. TERMINAL CABINETS FOR FIRE ALARM USE MUST BE LABELED "FATC" AND JUNCTION BOXES TO HAVE RED COVERS.

APPLICABLE CODES
2019 CALIFORNIA BUILDING CODE (2018 IBC AND 2019 CALIFORNIA AMENDMENTS) (2018 NFPA 101 AS REFERENCED BY CBC)
2019 CALIFORNIA ELECTRICAL CODE (2017 NEC AND 2019 CALIFORNIA AMENDMENTS)
2019 CALIFORNIA MECHANICAL CODE (2018 UMC AND 2019 CALIFORNIA AMENDMENTS)
2019 CALIFORNIA FIRE CODE (2018 IFC AND 2019 CALIFORNIA AMENDMENTS)
2018 NFPA 101 LIFE SAFETY CODE
2016 NFPA 72 NATIONAL FIRE PROTECTION ASSOCIATION
OSHPD POLICY INTENT AND CODE APPLICATION NOTICES

FIRESTOPPING
PENETRATIONS THRU WALLS REQUIRING PROTECTED OPENINGS SHALL BE FIRE STOPPED. FIRE STOP MATERIAL SHALL BE A UL LISTED ASSEMBLY INSTALLED ACCORDING TO THE MANUFACTURER'S INSTRUCTIONS. SEE DRAWING A9.0.01 AND "THROUGH PENETRATIONS FIRESTOP" BINDER FOR INFORMATION AND DETAILS

SEISMIC ANCHORAGE INFORMATION					
EQUIPMENT	ROOM #	DIMENSIONS (in) H x W x D	CABINET	OPERATING WEIGHT (LBS)	STRUCTURAL DETAIL / DRAWING NUMBER
LEVEL P3					
FATC-128	P3102	23.5" x 23.5" x 5.5"	-	40 (CABINET ONLY)	E8.24 / 9
BPS-B1	P3102	17" x 13" x 3.375"	BPS6A	33	E8.24 / 9
BPS-B2	P3102	17" x 13" x 3.375"	BPS6A	33	E8.24 / 9
BPS-B3	P3102	17" x 13" x 3.375"	BPS6A	33	E8.24 / 9
BPS-B4	P3102	17" x 13" x 3.375"	BPS6A	33	E8.24 / 9
UIO RCC CABINET	P3102	47.75" x 25" x 6.75"	3-RCC21R	80	E8.24 / 11
BPS-B5	P3313	17" x 13" x 3.375"	BPS6A	33	E8.24 / 9
LEVEL 1					
FACP-01	1801	49.75" x 27.34" x 5.81"	3-CAB21B	250	E8.24 / 11
BATTERY CASINET	1901	36.125" x 25" x 8.0"	3-RCC14R	135	E8.24 / 11
NODE-02	1901	47.75" x 25" x 6.75"	3-RCC21R	200	E8.24 / 11
NODE-03	1901	47.75" x 25" x 6.75"	3-RCC21R	200	E8.24 / 11
FATC-128	1801	23.5" x 23.5" x 5.5"	-	40 (CABINET ONLY)	E8.24 / 9
BPS-B7	1801	17" x 13" x 3.375"	BPS6A	33	E8.24 / 9
BPS-B8	1801	17" x 13" x 3.375"	BPS6A	33	E8.24 / 9
UIO RCC CABINET	1901	47.75" x 25" x 6.75"	3-RCC21R	120	E8.24 / 11
FAN-13	1801	41.228" x 29.413" x 4.625"	RSF-LGR	150	E8.24 / 11
GANN-14	1801	40.412" x 52.224" x 4.625"	RSF-LGR	275	E8.24 / 11
BPS-B6	1800	17" x 13" x 3.375"	BPS6A	33	E8.24 / 9
BPS-B9	1800	17" x 13" x 3.375"	BPS6A	33	E8.24 / 9
BPS-B10	1800	17" x 13" x 3.375"	BPS6A	33	E8.24 / 9
LEVEL 2					
NODE-04	2282	47.75" x 25" x 6.75"	3-RCC21R	200	E8.24 / 11
FATC-128	2282	23.5" x 23.5" x 5.5"	-	40 (CABINET ONLY)	E8.24 / 9
BPS-B11	2282	17" x 13" x 3.375"	BPS6A	33	E8.24 / 9
BPS-B12	2282	17" x 13" x 3.375"	BPS6A	33	E8.24 / 9
BPS-B13	2929	17" x 13" x 3.375"	BPS6A	33	E8.24 / 9
BPS-B14	2929	17" x 13" x 3.375"	BPS6A	33	E8.24 / 9
LEVEL 3					
NODE-05	3910	47.75" x 25" x 6.75"	3-RCC21R	220	E8.24 / 11
FATC-128	3910	23.5" x 23.5" x 5.5"	-	40 (CABINET ONLY)	E8.24 / 9
BPS-B15	3910	17" x 13" x 3.375"	BPS6A	33	E8.24 / 9
BPS-B16	3910	17" x 13" x 3.375"	BPS6A	33	E8.24 / 9
BPS-B17	3910	17" x 13" x 3.375"	BPS6A	33	E8.24 / 9
BPS-B18	3910	17" x 13" x 3.375"	BPS6A	33	E8.24 / 9
BPS-B19	3910	17" x 13" x 3.375"	BPS6A	33	E8.24 / 9
BPS-B20	3910	17" x 13" x 3.375"	BPS6A	33	E8.24 / 9
BPS-B21	3910	17" x 13" x 3.375"	BPS6A	33	E8.24 / 9
LEVEL 4					
NODE-06	4910	47.75" x 25" x 6.75"	3-RCC21R	220	E8.24 / 11
FATC-128	4910	23.5" x 23.5" x 5.5"	-	40 (CABINET ONLY)	E8.24 / 9
BPS-B22	4910	17" x 13" x 3.375"	BPS6A	33	E8.24 / 9
BPS-B23	4910	17" x 13" x 3.375"	BPS6A	33	E8.24 / 9
BPS-B24	4910	17" x 13" x 3.375"	BPS6A	33	E8.24 / 9
BPS-B25	4910	17" x 13" x 3.375"	BPS6A	33	E8.24 / 9
BPS-B26	4910	17" x 13" x 3.375"	BPS6A	33	E8.24 / 9
BPS-B27	4910	17" x 13" x 3.375"	BPS6A	33	E8.24 / 9

SMOKE DETECTION
SMOKE DETECTION IS REQUIRED IN PATIENT AND CLIENT SLEEPING ROOMS, FOR THE PURPOSES OF CAUSING VISUAL DISPLAY ON THE CORRIDOR SIDE OF THE ROOM AND AN AUDIBLE AND VISUAL ALARM AT THE NURSE'S STATION. SMOKE DETECTORS ARE ALSO REQUIRED FOR THE PURPOSES OF ELEVATOR RECALL AND ACTUATION OF AUTOMATIC CLOSING, FIRE SEPARATION DOORS INSTALLED IN SMOKE BARRIERS, ACROSS CORRIDORS AND LOCATIONS OUTLINED IN SECTION 715.4.7.3 OF 2007 CBC.
FOR CONTROL OF SPREAD OF SMOKE, SMOKE DAMPERS CAN BE CONTROLLED BY THE SMOKE DETECTION SYSTEM PROVIDED THAT A TOTAL COVERAGE SMOKE DETECTION SYSTEM IS INSTALLED WITHIN THE AREAS SERVED BY THE HEATING, VENTILATION AND AIR CONDITIONING SYSTEM. 2007 CBC 716.3.2.1, ITEM 5. THE DESIGN INTENT OF THIS PROJECT IS TO PROVIDE TOTAL COVERAGE SMOKE DETECTORS IN THE I-2 OCCUPANCY AREA THAT ARE SERVED DIRECTLY BY THE AIR-SUPPLY SYSTEM, PROVIDED THAT EXHAUST AIR DUCTS OPEN DIRECTLY TO THE EXTERIOR. THIS COVERAGE IS BEING PLACED SPECIFICALLY FOR SMOKE DAMPER AND ANY DELAYED EGRESS AREAS. IT IS OUR UNDERSTANDING THAT THE DEFINITION OF TOTAL COVERAGE DETECTION AS DEFINED BY NFPA 72 (2007 EDITION) IS NOT APPLICABLE WHEN DISCUSSING THE ITEMS LISTED ABOVE THAT REFERENCE TOTAL COVERAGE FOR AREAS SERVED BY THE HVAC SYSTEMS.

PATIENT ROOM SMOKE DETECTOR ANNUNCIATION
PATIENT ROOM SMOKE DETECTORS ARE EQUIPPED WITH A RELAY BASE TO INTERFACE WITH A RAULAND RESPONDER 5 NURSE CALL SYSTEM WITH THE DOME LIGHT. ANNUNCIATION AT THE DOME LIGHT AND AT THE NURSE STATION WILL BE HANDLED THROUGH THE RAULAND NURSE CALL SYSTEM. PLEASE SEE DETAIL J ON SHEET FA.4.14 FOR THE UL LISTING FOR THIS SYSTEM.

SEISMIC ANCHORAGE INFORMATION					
EQUIPMENT	ROOM #	DIMENSIONS (in) H x W x D	CABINET	OPERATING WEIGHT (LBS)	STRUCTURAL DETAIL / DRAWING NUMBER
LEVEL 5					
NODE-07	5810	47.75" x 25" x 6.75"	3-RCC21R	220	E8.24 / 11
FATC-128	5910	23.5" x 23.5" x 5.5"	-	40 (CABINET ONLY)	E8.24 / 9
BPS-B28	5910	17" x 13" x 3.375"	BPS6A	33	E8.24 / 9
BPS-B29	5910	17" x 13" x 3.375"	BPS6A	33	E8.24 / 9
BPS-B30	5910	17" x 13" x 3.375"	BPS6A	33	E8.24 / 9
BPS-B31	5910	17" x 13" x 3.375"	BPS6A	33	E8.24 / 9
BPS-B32	5910	17" x 13" x 3.375"	BPS6A	33	E8.24 / 9
BPS-B33	5910	17" x 13" x 3.375"	BPS6A	33	E8.24 / 9
LEVEL 6					
NODE-08	6910	47.75" x 25" x 6.75"	3-RCC21R	220	E8.24 / 11
FATC-128	6910	23.5" x 23.5" x 5.5"	-	40 (CABINET ONLY)	E8.24 / 9
BPS-B34	6910	17" x 13" x 3.375"	BPS6A	33	E8.24 / 9
BPS-B35	6910	17" x 13" x 3.375"	BPS6A	33	E8.24 / 9
BPS-B36	6910	17" x 13" x 3.375"	BPS6A	33	E8.24 / 9
BPS-B37	6910	17" x 13" x 3.375"	BPS6A	33	E8.24 / 9
BPS-B38	6910	17" x 13" x 3.375"	BPS6A	33	E8.24 / 9
LEVEL 7					
NODE-09	7910	47.75" x 25" x 6.75"	3-RCC21R	220	E8.24 / 11
FATC-128	7910	23.5" x 23.5" x 5.5"	-	40 (CABINET ONLY)	E8.24 / 9
BPS-B39	7910	17" x 13" x 3.375"	BPS6A	33	E8.24 / 9
BPS-B40	7910	17" x 13" x 3.375"	BPS6A	33	E8.24 / 9
BPS-B41	7910	17" x 13" x 3.375"	BPS6A	33	E8.24 / 9
LEVEL 8					
FATC-128	8910	23.5" x 23.5" x 5.5"	-	40 (CABINET ONLY)	E8.24 / 9
BPS-B42	8910	17" x 13" x 3.375"	BPS6A	33	E8.24 / 9
BPS-B43	8910	17" x 13" x 3.375"	BPS6A	33	E8.24 / 9
BPS-B44	8910	17" x 13" x 3.375"	BPS6A	33	E8.24 / 9
LEVEL 9					
NODE-10	9910	47.75" x 25" x 6.75"	3-RCC21R	220	E8.24 / 11
FATC-128	9910	23.5" x 23.5" x 5.5"	-	40 (CABINET ONLY)	E8.24 / 9
BPS-B45	9910	17" x 13" x 3.375"	BPS6A	33	E8.24 / 9
BPS-B46	9910	17" x 13" x 3.375"	BPS6A	33	E8.24 / 9
BPS-B47	9910	17" x 13" x 3.375"	BPS6A	33	E8.24 / 9
LEVEL 10					
FATC-128	10910	23.5" x 23.5" x 5.5"	-	40 (CABINET ONLY)	E8.24 / 9
BPS-B48	10910	17" x 13" x 3.375"	BPS6A	33	E8.24 / 9
BPS-B49	10910	17" x 13" x 3.375"	BPS6A	33	E8.24 / 9
BPS-B50	10910	17" x 13" x 3.375"	BPS6A	33	E8.24 / 9
LEVEL 11					
FATC-128	11910	23.5" x 23.5" x 5.5"	-	40 (CABINET ONLY)	E8.24 / 9
BPS-B51	11910	17" x 13" x 3.375"	BPS6A	33	E8.24 / 9
BPS-B52	11910	17" x 13" x 3.375"	BPS6A	33	E8.24 / 9
LEVEL 12					
NODE-11	12308	47.75" x 25" x 6.75"	3-RCC21R	220	E8.24 / 11
FATC-128	12311	23.5" x 23.5" x 5.5"	-	40 (CABINET ONLY)	E8.24 / 9
BPS-B53	12311	17" x 13" x 3.375"	BPS6A	33	E8.24 / 9
BPS-B54	12311	17" x 13" x 3.375"	BPS6A	33	E8.24 / 9
UIO RCC CABINET	12311	47.75" x 25" x 6.75"	3-RCC21R	120	E8.24 / 11

SHEET SCHEDULE			
SHEET NO.	TITLE	SHEET NO.	TITLE
FA.0.01	FIRE ALARM COVER SHEET	FA.08.2	LEVEL 8 AREAS C, D, E & F - ZONE 2
FA.0.01A	FIRE ALARM SEQUENCE OF OPERATION MATRIX A	FA.09.0	LEVEL 9 OVERALL PLAN
FA.0.01B	FIRE ALARM SEQUENCE OF OPERATION MATRIX B	FA.09.1	LEVEL 9 AREAS A, B, G & H - ZONE 1
FA.0.01C	FIRE ALARM SEQUENCE OF OPERATION MATRIX C	FA.09.2	LEVEL 9 AREAS C, D, E & F - ZONE 2
FA.0.01D	FIRE ALARM SEQUENCE OF OPERATION MATRIX D	FA.10.0	LEVEL 10 OVERALL PLAN
FA.0.01E	FIRE ALARM SEQUENCE OF OPERATION MATRIX E	FA.10.1	LEVEL 10 AREAS A, B, G & H - ZONE 1
FA.0.01F	FIRE ALARM SEQUENCE OF OPERATION MATRIX F	FA.10.2	LEVEL 10 AREAS C, D, E & F - ZONE 2
FA.0.01G	FIRE ALARM VOICE AND PAGING ZONE MATRIX	FA.11.0	LEVEL 11 OVERALL PLAN
FA.0.01H	FIRE ALARM ELEVATOR CONTROL FUNCTION - ELEV. GROUP 1,2,8,7,9	FA.11.1	LEVEL 11 AREAS A, B, G & H - ZONE 1
FA.0.01I	FIRE ALARM ELEVATOR CONTROL FUNCTION - ELEV. GROUP 3,4,5,6,10	FA.11.2	LEVEL 11 AREAS C, D, E & F - ZONE 2
FA.0.02	FIRE ALARM PLAN LEGENDS	FA.12.0	LEVEL 12 OVERALL PLAN
FA.0.03	FIRE ALARM PLAN DOOR SCHEDULE	FA.12.1	LEVEL 12 AREAS A, B, G & H - ZONE 1
FA.0.04	FIRE ALARM PLAN MECHANICAL OPERATIONAL MATRIX	FA.12.2	LEVEL 12 AREAS C, D, E & F - ZONE 2
FA.0.04A	FIRE ALARM PLAN MECHANICAL KITCHEN HOOD & FCU MATRIX	FA.13.0	LEVEL 13 OVERALL PLAN
FA.0.04B	FIRE ALARM PLAN MECHANICAL GARAGE VENTILATION CONTROL DIAGRAM	FA.13.1	LEVEL 13 AREAS A, B, G & H - ZONE 1
FA.0.05	FIRE ALARM MECHANICAL FSD SCHEDULE	FA.13.2	LEVEL 13 AREAS C, D, E & F - ZONE 2
FA.0.06	FIRE ALARM MECHANICAL FSD SCHEDULE CONTINUED AND FAN MATRIX	FA.2.01	SYSTEM RISER DIAGRAM
FA.0.07	FIRE ALARM AND BMS CLARIFICATION AND COORDINATION A	FA.2.02	STAIR & ELEVATOR RISER DIAGRAM
FA.0.08	FIRE ALARM AND BMS CLARIFICATION AND COORDINATION B	FA.2.03	NETWORK DATA, AUDIO DATA AND 24VDC POWER SCHEMATICS
FA.P.0.0	LEVEL P3 OVERALL PLAN	FA.2.04	NOTIFICATION AND INITIATING DEVICE RISER DIAGRAM - LEVELS P3 - P2
FA.P.1	LEVEL P3 AREAS A, B, G & H - ZONE 1	FA.2.05	NOTIFICATION AND INITIATING DEVICE RISER DIAGRAM - LEVEL 1
FA.P.2	LEVEL P3 AREAS C, D, E & F - ZONE 2	FA.2.06	NOTIFICATION AND INITIATING DEVICE RISER DIAGRAM - LEVEL 2
FA.P.3	LEVEL P3 AREAS K & J - ZONE 3	FA.2.07A	NOTIFICATION DEVICE RISER DIAGRAM - LEVEL 3
FA.P.4	LEVEL P3 AREAS M & L - ZONE 4	FA.2.07B	INITIATING DEVICE RISER DIAGRAM - LEVEL 3
FA.P.0	LEVEL P2 OVERALL PLAN	FA.2.08A	NOTIFICATION AND INITIATING DEVICE RISER DIAGRAM - LEVEL 4
FA.P.1	LEVEL P2 AREAS A, B, G & H - ZONE 1	FA.2.08B	INITIATING DEVICE RISER DIAGRAM - LEVEL 4
FA.P.2	LEVEL P2 AREAS C, D, E & F - ZONE 2	FA.2.08A	NOTIFICATION DEVICE RISER DIAGRAM - LEVEL 5
FA.P.3	LEVEL P2 AREAS K & J - ZONE 3	FA.2.08B	INITIATING DEVICE RISER DIAGRAM - LEVEL 5
FA.P.4	LEVEL P2 AREAS M & L - ZONE 4	FA.2.10A	NOTIFICATION DEVICE RISER DIAGRAM - LEVEL 6
FA.0.10	LEVEL 1 / P1 OVERALL PLAN	FA.2.10B	INITIATING DEVICE RISER DIAGRAM - LEVEL 6
FA.0.11	LEVEL 1 / P1 AREAS A, B, G & H - ZONE 1	FA.2.11	NOTIFICATION AND INITIATING DEVICE RISER DIAGRAM - LEVEL 7
FA.0.12	LEVEL 1 / P1 AREAS C, D, E & F - ZONE 2	FA.2.12	NOTIFICATION AND INITIATING DEVICE RISER DIAGRAM - LEVEL 8
FA.0.13	LEVEL 1 / P1 AREAS K & J - ZONE 3	FA.2.13	NOTIFICATION AND INITIATING DEVICE RISER DIAGRAM - LEVEL 9
FA.0.14	LEVEL 1 / P1 AREAS M & L - ZONE 4	FA.2.14	NOTIFICATION AND INITIATING DEVICE RISER DIAGRAM - LEVEL 10
FA.0.2.0	LEVEL 2 OVERALL PLAN	FA.2.15	NOTIFICATION AND INITIATING DEVICE RISER DIAGRAM - LEVEL 11
FA.0.2.1	LEVEL 2 AREAS A, B, G & H - ZONE 1	FA.2.16	NOTIFICATION AND INITIATING DEVICE RISER DIAGRAM - LEVELS 12 - 13
FA.0.2.2	LEVEL 2 AREAS C, D, E & F - ZONE 2	FA.3.01	FIRE ALARM CONTROL ROOM ELEVATIONS
FA.0.2.3	LEVEL 2 AREAS K & J - ZONE 3	FA.4.01	NODE HARDWARE LAYERS
FA.0.2.4	LEVEL 2 AREAS M & L - ZONE 4	FA.4.02	FACP 01 - NODE 03 LRM LAYERS
FA.0.3.0	LEVEL 3 OVERALL PLAN	FA.4.03	NODE 04 - NODE 06 LRM LAYERS
FA.0.3.1	LEVEL 3 AREAS A, B, G & H - ZONE 1	FA.4.03A	FATC 1 -



VNGC Expanded Matrix

Fire Command Center Control Unit Annunciation

Remote Annunciation

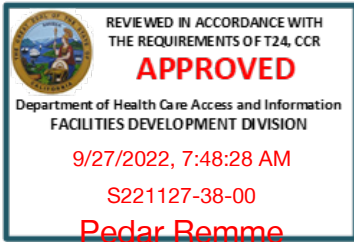
Notification

**Nurse
Call**

Elev

Door Control

FSD Control
(For Fan Control see Fan control Matrix)

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HCAI PLAN REVIEW

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4TH FLOOR ACU AUTOMATIC DOOR OPERATORS





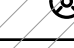
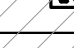
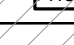






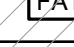
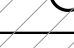
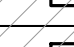
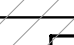
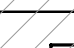


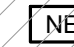
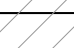

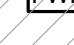
FIRE ALARM PLAN SEQUENCE OF OPERATION MATRIX E

[illegible]

ALL CHANGES TO THE INFORMATION IN THIS DOCUMENT MUST BE APPROVED BY RFI OR ACD AND BY THE SYSTEM DESIGNER (CONVERGENT TECHNOLOGIES) PRIOR TO MAKING CHANGES IN THE FIELD.

SYMBOL LEGEND								
SYM.	MFG.	MODEL #	TOTAL QTY.	ACU ADJ. TL QTY.	DESCRIPTION	BACKBOX	CSFM	
FACP 01	EST	EST-3	-	-	FIRE ALARM CONTROL PANEL	3-CAB21B	7165-1657-0186	
		3-CPU3	1	-	CENTRAL PROCESSING UNIT MODULE	3-CAB21B	7165-1657-0186	
		3-RS485A	1	-	NETWORK COMMUNICATIONS CARD	3-CAB21B	7165-1657-0186	
		3-RS232	1	-	RS-232 COMMUNICATION CARD	3-CAB21B	7165-1657-0186	
		3-PPS1M	1	-	PRIMARY POWER SUPPLY WITH LOCAL RAIL MODULE	3-CAB21B	7165-1657-0186	
		3-MODCOM	1	-	MODEM/DIALER (DACT)	3-CAB21B	7165-1657-0186	
		3-SDDC1	1	-	DUAL SIGNATURE DRIVER CONTROLLER	3-CAB21B	7165-1657-0186	
		3-ASURF	1	-	AUDIO SOURCE UNIT WITH MICROPHONE & TELEPHONE	3-CAB21B	7165-1657-0186	
		3-1LCD	1	-	LIQUID CRYSTAL DISPLAY MODULE	3-CAB21B	7165-1657-0186	
		3-12S1GY	3	-	12 SWITCHES W/ 1 GRN & 1 YLW LED PER SWITCH DISPLAY	3-CAB21B	7165-1657-0186	
BATT	BY OTHERS	3-LRMF	2	-	LOCAL RAIL MODULE FILLER	3-CAB21B	7165-1657-0186	
		3-XFP	1	-	EXTENDER FILLER PLATE	3-CAB21B	7165-1657-0186	
		3-CHAS7	3	-	CHASSIS ASSEMBLY - 7 LOCAL RAIL MODULE SPACES	3-CAB21B	7165-1657-0186	
		3-CAB21B	1	-	WALLOBX	INCLUDED	7165-1657-0186	
		3-CAB21D	1	-	NNER & OUTER DOORS FOR WALLOBX	3-CAB21B	7165-1657-0186	
		3-RCC14R	1	-	BATTERY CABINET	INCLUDED	7165-1657-0186	
		3-BATS1	1	-	BATTERY SHELF	3-RCC14R	7165-1657-0186	
		3-12V50A	2	-	50AH BATTERY	3-RCC14R	-	
		3-RJ31X	1	-	ALARM SYSTEM JACK	3-RCC14R	-	
		3-RCCE0-65	1	-	EARTHQUAKE BRACE FOR 65AH BATTERY	3-RCC14R	-	
NODE 02	CE AUTO ELECTRIC	ATC7.5	1	-	7.5A ATC FUSE	3-RCC14R	-	
		FPATC3	3	-	3-POSITION ATC FUSE PANEL W/POWER DISTRIBUTION	3-RCC14R	-	
		EST-3	-	-	FIRE ALARM NODE 02	3-CAB21B	7165-1657-0186	
		3-CPU3	1	-	CENTRAL PROCESSING UNIT MODULE	3-CAB21B	7165-1657-0186	
		3-RS485A	1	-	NETWORK COMMUNICATIONS CARD	3-CAB21B	7165-1657-0186	
		3-PPS1M	1	-	PRIMARY POWER SUPPLY WITH LOCAL RAIL MODULE	3-CAB21B	7165-1657-0186	
		3-BPS1M	1	-	BOOSTER POWER SUPPLY WITH LOCAL RAIL MODULE	3-CAB21B	7165-1657-0186	
		3-2A20B	4	-	20 WATT ZONED AUDIO AMPLIFIER	3-CAB21B	7165-1657-0186	
		3-2A40B	5	-	40 WATT ZONED AUDIO AMPLIFIER	3-CAB21B	7165-1657-0186	
		3-CHAS7	3	-	CHASSIS ASSEMBLY - 7 LOCAL RAIL MODULE SPACES	3-RCC21R	7165-1657-0186	
BATT	EST	3-RCC21R	1	-	RED WALLOBX & DOOR	INCLUDED	7165-1657-0186	
		3-RCC14R	1	-	BATTERY CABINET	INCLUDED	7165-1657-0186	
		3-BATS1	1	-	BATTERY SHELF	3-RCC14R	-	
		3-12V50A	2	-	50AH BATTERY	3-RCC14R	-	
		3-BATS1	1	-	50AH BATTERY	3-RCC14R	-	
		3-12V50A	2	-	50AH BATTERY	3-RCC14R	-	
		3-RCCE0-50	1	-	EARTHQUAKE BRACE FOR 50AH BATTERY	3-RCC14R	-	
		ATC7.5	1	-	7.5A ATC FUSE	3-RCC14R	-	
		FPATC3	2	-	3-POSITION ATC FUSE PANEL W/POWER DISTRIBUTION	3-RCC14R	-	
		EST-3	-	-	FIRE ALARM NODE 03	3-CAB21B	7165-1657-0186	
NODE 03	CE AUTO ELECTRIC	3-CPU3	1	-	CENTRAL PROCESSING UNIT MODULE	3-CAB21B	7165-1657-0186	
		3-RS485A	1	-	NETWORK COMMUNICATIONS CARD	3-CAB21B	7165-1657-0186	
		3-PPS1M	1	-	PRIMARY POWER SUPPLY WITH LOCAL RAIL MODULE	3-CAB21B	7165-1657-0186	
		3-BPS1M	1	-	BOOSTER POWER SUPPLY WITH LOCAL RAIL MODULE	3-CAB21B	7165-1657-0186	
		3-SDDC1	1	-	SINGLE SIGNATURE DRIVER CONTROLLER	3-CAB21B	7165-1657-0186	
		3-2A40B	5	-	40 WATT ZONED AUDIO AMPLIFIER	3-CAB21B	7165-1657-0186	
		3-CHAS7	3	-	CHASSIS ASSEMBLY - 7 LOCAL RAIL MODULE SPACES	3-RCC21R	7165-1657-0186	
		3-RCC21R	1	-	RED WALLOBX & DOOR	INCLUDED	7165-1657-0186	
		3-RCC14R	1	-	BATTERY CABINET	INCLUDED	7165-1657-0186	
		3-BATS1	1	-	BATTERY SHELF	3-RCC14R	-	
BATT	CE AUTO ELECTRIC	3-12V50A	2	-	50AH BATTERY	3-RCC14R	-	
		3-RCCE0-50	1	-	EARTHQUAKE BRACE FOR 50AH BATTERY	3-RCC14R	-	
		ATC7.5	1	-	7.5A ATC FUSE	3-RCC14R	-	
		FPATC3	2	-	3-POSITION ATC FUSE PANEL W/POWER DISTRIBUTION	3-RCC14R	-	
		EST-3	-	-	FIRE ALARM NODE 04	3-CAB21B	7165-1657-0186	
		3-CPU3	1	-	CENTRAL PROCESSING UNIT MODULE	3-CAB21B	7165-1657-0186	
		3-RS485A	1	-	NETWORK COMMUNICATIONS CARD	3-CAB21B	7165-1657-0186	
		3-PPS1M	1	-	PRIMARY POWER SUPPLY WITH LOCAL RAIL MODULE	3-CAB21B	7165-1657-0186	
		3-BPS1M	1	-	BOOSTER POWER SUPPLY WITH LOCAL RAIL MODULE	3-CAB21B	7165-1657-0186	
		3-SDDC1	1	-	DUAL SIGNATURE DRIVER CONTROLLER	3-CAB21B	7165-1657-0186	
NODE 04	CE AUTO ELECTRIC	3-2A40B	5	-	40 WATT ZONED AUDIO AMPLIFIER	3-CAB21B	7165-1657-0186	
		3-CHAS7	3	-	CHASSIS ASSEMBLY - 7 LOCAL RAIL MODULE SPACES	3-RCC21R	7165-1657-0186	
		3-RCC21R	1	-	RED WALLOBX & DOOR	INCLUDED	7165-1657-0186	
		3-RCC14R	1	-	BATTERY CABINET	INCLUDED	7165-1657-0186	
		3-BATS1	1	-	BATTERY SHELF	3-RCC14R	-	
		3-12V50A	2	-	50AH BATTERY	3-RCC14R	-	
		3-RCCE0-50	1	-	EARTHQUAKE BRACE FOR 50AH BATTERY	3-RCC14R	-	
		ATC7.5	1	-	7.5A ATC FUSE	3-RCC14R	-	
		FPATC3	2	-	3-POSITION ATC FUSE PANEL W/POWER DISTRIBUTION	3-RCC14R	-	
		EST-3	-	-	FIRE ALARM NODE 05	3-CAB21B	7165-1657-0186	
NODE 05	EST	3-CPU3	1	-	CENTRAL PROCESSING UNIT MODULE	3-CAB21B	7165-1657-0186	
		3-RS485A	1	-	NETWORK COMMUNICATIONS CARD	3-CAB21B	7165-1657-0186	
		3-PPS1M	1	-	PRIMARY POWER SUPPLY WITH LOCAL RAIL MODULE	3-CAB21B	7165-1657-0186	
		3-BPS1M	2	-	BOOSTER POWER SUPPLY WITH LOCAL RAIL MODULE	3-CAB21B	7165-1657-0186	
		3-SDDC1	2	-	DUAL SIGNATURE DRIVER CONTROLLER	3-CAB21B	7165-1657-0186	
		3-2A20B	3	-	20 WATT ZONED AUDIO AMPLIFIER	3-CAB21B	7165-1657-0186	
		3-2A40B	5	-	40 WATT ZONED AUDIO AMPLIFIER	3-CAB21B	7165-1657-0186	
		3-CHAS7	3	-	CHASSIS ASSEMBLY - 7 LOCAL RAIL MODULE SPACES	3-RCC21R	7165-1657-0186	
		3-RCC21R	1	-	RED WALLOBX & DOOR	INCLUDED	7165-1657-0186	
		3-RCC14R	1	-	BATTERY CABINET	INCLUDED	7165-1657-0186	
BATT	EST	3-BATS1	1	-	BATTERY SHELF	3-RCC14R	-	
		3-12V50A	2	-	50AH BATTERY	3-RCC14R	-	
		3-RCCE0-50	1	-	EARTHQUAKE BRACE FOR 50AH BATTERY	3-RCC14R	-	
		ATC7.5	1	-	7.5A ATC FUSE	3-RCC14R	-	
		FPATC3	2	-	3-POSITION ATC FUSE PANEL W/POWER DISTRIBUTION	3-RCC14R	-	
		EST-3	-	-	FIRE ALARM NODE 06	3-CAB21B	7165-1657-0186	
		3-CPU3	1	-	CENTRAL PROCESSING UNIT MODULE	3-CAB21B	7165-1657-0186	
		3-RS485A	1	-	NETWORK COMMUNICATIONS CARD	3-CAB21B	7165-1657-0186	
		3-PPS1M	1	-	PRIMARY POWER SUPPLY WITH LOCAL RAIL MODULE	3-CAB21B	7165-1657-0186	
		3-BPS1M	2	-	BOOSTER POWER SUPPLY WITH LOCAL RAIL MODULE	3-CAB21B	7165-1657-0186	
NODE 06	EST	3-SDDC1	1	-	SINGLE SIGNATURE DRIVER CONTROLLER	3-CAB21B	7165-1657-0186	
		3-SDDC1	2	-	DUAL SIGNATURE DRIVER CONTROLLER	3-CAB21B	7165-1657-0186	
		3-2A20B	4	-	20 WATT ZONED AUDIO AMPLIFIER	3-CAB21B	7165-1657-0186	
		3-2A40B	4	-	40 WATT ZONED AUDIO AMPLIFIER	3-CAB21B	7165-1657-0186	
		3-CHAS7	3	-	CHASSIS ASSEMBLY - 7 LOCAL RAIL MODULE SPACES	3-RCC21R	7165-1657-0186	
		3-RCC21R	1	-	RED WALLOBX & DOOR	INCLUDED	7165-1657-0186	
		3-RCC14R	1	-	BATTERY CABINET	INCLUDED	7165-1657-0186	
		3-BATS1	1	-	BATTERY SHELF	3-RCC14R	-	
		3-12V50A	2	-	50AH BATTERY	3-RCC14R	-	
		3-RCCE0-50	1	-	EARTHQUAKE BRACE FOR 50AH BATTERY	3-RCC14R	-	
BATT	CE AUTO ELECTRIC	ATC7.5	1	-	7.5A ATC FUSE	3-RCC14R	-	
		FPATC3	2	-	3-POSITION ATC FUSE PANEL W/POWER DISTRIBUTION	3-RCC14R	-	
		EST-3	-	-	FIRE ALARM NODE 07	3-CAB21B	7165-1657-0186	
		3-CPU3	1	-	CENTRAL PROCESSING UNIT MODULE	3-CAB21B	7165-1657-0186	
		3-RS485A	1	-	NETWORK COMMUNICATIONS CARD	3-CAB21B	7165-1657-0186	
		3-PPS1M	1	-	PRIMARY POWER SUPPLY WITH LOCAL RAIL MODULE	3-CAB21B	7165-1657-0186	
		3-BPS1M	2	-	BOOSTER POWER SUPPLY WITH LOCAL RAIL MODULE	3-CAB21B	7165-1657-0186	
		3-SDDC1	1	-	SINGLE SIGNATURE DRIVER CONTROLLER	3-CAB21B	7165-1657-0186	
		3-SDDC1	2	-	DUAL SIGNATURE DRIVER CONTROLLER	3-CAB21B	7165-1657-0186	
		3-2A20B	3	-	20 WATT ZONED AUDIO AMPLIFIER	3-CAB21B	7165-1657-0186	
NODE 07	EST	3-2A40B	3	-	40 WATT ZONED AUDIO AMPLIFIER	3-CAB21B	7165-1657-0186	
		3-CHAS7	3	-	CHASSIS ASSEMBLY - 7 LOCAL RAIL MODULE SPACES	3-RCC21R	7165-1657-0186	
		3-RCC21R	1	-	RED WALLOBX & DOOR	INCLUDED	7165-1657-0186	
		3-RCC14R	1	-	BATTERY CABINET	INCLUDED	7165-1657-0186	
		3-BATS1	1	-	BATTERY SHELF	3-RCC14R	-	
		3-12V50A	2	-	50AH BATTERY	3-RCC14R	-	
		3-RCCE0-50	1	-	EARTHQUAKE BRACE FOR 50AH BATTERY	3-RCC14R	-	
		ATC7.5	1	-	7.5A ATC FUSE	3-RCC14R	-	
		FPATC3	2	-	3-POSITION ATC FUSE PANEL W/POWER DISTRIBUTION	3-RCC14R	-	
		EST-3	-	-	FIRE ALARM NODE 08	3-CAB21B	7165-1657-0186	
NODE 08	EST	3-CPU3	1	-	CENTRAL PROCESSING UNIT MODULE	3-CAB21B	7165-1657-0186	
		3-RS485A	1	-	NETWORK COMMUNICATIONS CARD	3-CAB21B	7165-1657-0186	
		3-PPS1M	1	-	PRIMARY POWER SUPPLY WITH LOCAL RAIL MODULE	3-CAB21B	7165-1657-0186	
		3-BPS1M	1	-	BOOSTER POWER SUPPLY WITH LOCAL RAIL MODULE	3-CAB21B	7165-1657-0186	
		3-SDDC1	1	-	SINGLE SIGNATURE DRIVER CONTROLLER	3-CAB21B	7165-1657-0186	
		3-SDDC1	2	-	DUAL SIGNATURE DRIVER CONTROLLER	3-CAB21B	7165-1657-0186	
		3-2A20B	1	-	20 WATT ZONED AUDIO AMPLIFIER	3-CAB21B	7165-1657-0186	
		3-2A40B	5	-	40 WATT ZONED AUDIO AMPLIFIER	3-CAB21B	7165-1657-0186	
		3-CHAS7	3	-	CHASSIS ASSEMBLY - 7 LOCAL RAIL MODULE SPACES	3-RCC21R	7165-1657-0186	
		3-RCC21R	1	-	RED WALLOBX & DOOR	INCLUDED	7165-1657-0186	
BATT	EST	3-RCC14R	1	-	BATTERY CABINET	INCLUDED	7165-1657-0186	
		3-BATS1	1	-	BATTERY SHELF	3-RCC14R	-	
		3-12V50A	2	-	50AH BATTERY	3-RCC14R	-	
		3-RCCE0-50	1	-	EARTHQUAKE BRACE FOR 50AH BATTERY	3-RCC14R	-	
		ATC7.5	1	-	7.5A ATC FUSE	3-RCC14R	-	
		FPATC3	2	-	3-POSITION ATC FUSE PANEL W/POWER DISTRIBUTION	3-RCC14R	-	
		EST-3	-	-	FIRE ALARM NODE 09	3-CAB21B	7165-1657-0186	
		3-CPU3	1	-	CENTRAL PROCESSING UNIT MODULE	3-CAB21B	7165-1657-0186	
		3-RS485A	1	-	NETWORK COMMUNICATIONS CARD	3-CAB21B	7165-1657-0186	
		3-PPS1M	1	-	PRIMARY POWER SUPPLY WITH LOCAL RAIL MODULE	3-CAB21B	7165-1657-0186	
NODE 09	CE AUTO ELECTRIC	3-BPS1M	1	-	BOOSTER POWER SUPPLY WITH LOCAL RAIL MODULE	3-CAB21B	7165-1657-0186	
		3-SDDC1	1	-	SINGLE SIGNATURE DRIVER CONTROLLER	3-CAB21B	7165-1657-0186	
		3-SDDC1	2	-	DUAL SIGNATURE DRIVER CONTROLLER	3-CAB21B	7165-1657-0186	
		3-2A20B	1	-	20 WATT ZONED AUDIO AMPLIFIER	3-CAB21B	7165-1657-0186	
		3-2A40B	5	-	40 WATT ZONED AUDIO AMPLIFIER	3-CAB21B	7165-1657-0186	
		3-CHAS7	3	-	CHASSIS ASSEMBLY - 7 LOCAL RAIL MODULE SPACES	3-RCC21R	7165-1657-0186	
		3-RCC21R	1	-	RED WALLOBX & DOOR	INCLUDED	7165-1657-0186	
		3-RCC14R	1	-	BATTERY CABINET	INCLUDED	7165-1657-0186	
		3-BATS1	1	-	BATTERY SHELF	3-RCC14R	-	
		3-12V50A	2	-	50AH BATTERY	3-RCC14R	-	
BATT	CE AUTO ELECTRIC	3-RCCE0-50	1	-	EARTHQUAKE BRACE FOR 50AH BATTERY	3-RCC14R	-	
		ATC7.5	1	-	7.5A ATC FUSE	3-RCC14R	-	
		FPATC3	2	-	3-POSITION ATC FUSE PANEL W/POWER DISTRIBUTION	3-RCC14R	-	
		EST-3	-	-	FIRE ALARM NODE 10	3-CAB21B	7165-1657-0186	
		3-CPU3	1	-	CENTRAL PROCESSING UNIT MODULE	3-CAB21B	7165-1657-0186	
		3-RS485A	1	-	NETWORK COMMUNICATIONS CARD	3-CAB21B	7165-1657-0186	
		3-PPS1M	1	-	PRIMARY POWER SUPPLY WITH LOCAL RAIL MODULE	3-CAB21B	7165-1657-0186	
		3-BPS1M	1	-	BOOSTER POWER SUPPLY WITH LOCAL RAIL MODULE	3-CAB21B	7165-1657-0186	
		3-SDDC1	1	-	SINGLE SIGNATURE DRIVER CONTROLLER	3-CAB21B	7165-1657-0186	
		3-SDDC1	2	-	DUAL SIGNATURE DRIVER CONTROLLER	3-CAB21B	7165-1657-0186	

		SYMBOL LEGEND						
SYM.	MFG.	MODEL #	TOTAL QTY.	ACU APO T1 QTY.	DESCRIPTION	BACKBOX	CSFM	
NODE 10	EST	EST-3	-	-	FIRE ALARM NODE 10	3-CAB21B	7165-1657-0186	
		3-CPU3	1	1	CENTRAL PROCESSING UNIT MODULE	3-CAB21B	7165-1657-0186	
		3-RS485A	1	1	NETWORK COMMUNICATIONS CARD	3-CAB21B	7165-1657-0186	
		3-PPSM	1	1	PRIMARY POWER SUPPLY WITH LOCAL RAIL MODULE	3-CAB21B	7165-1657-0186	
		3-BPSM	1	1	BOOSTER POWER SUPPLY WITH LOCAL RAIL MODULE	3-CAB21B	7165-1657-0186	
		3-SDDC1	3	3	DUAL SIGNATURE DRIVER CONTROLLER	3-CAB21B	7165-1657-0186	
		3-2A40B	5	5	40 WATT ZONED AUDIO AMPLIFIER	3-CAB21B	7165-1657-0186	
		3-CHAS7	1	1	CHASSIS ASSEMBLY - 7 LOCAL RAIL MODULE SPACES	3-CAB21B	7165-1657-0186	
		3-RCC21R	1	1	RED WALLBOX & DOOR	INCLUDED	7165-1657-0186	
		3-RCC14R	1	1	BATTERY CABINET	INCLUDED	7165-1657-0186	
BATT	EST	3-BATS	1	1	BATTERY SHELF	3-RCC14R	-	
	EST	12V50A	2	2	50AH BATTERY	3-RCC14R	-	
	EST	3-RCC2EQ-50	1	1	EARTHQUAKE BRACE FOR 50AH BATTERY	3-RCC14R	-	
	CE AUTO ELECTRIC	ATC7.5	1	1	7.5A ATC FUSE	3-RCC14R	-	
	CE AUTO ELECTRIC	FPATC3	2	2	3-POSITION ATC FUSE PANEL W/POWER DISTRIBUTION	3-RCC14R	-	
	EST	EST-3	-	-	FIRE ALARM NODE 11	3-CAB21B	7165-1657-0186	
		3-CPU3	1	1	CENTRAL PROCESSING UNIT MODULE	3-CAB21B	7165-1657-0186	
		3-RS485A	1	1	NETWORK COMMUNICATIONS CARD	3-CAB21B	7165-1657-0186	
		3-PPSM	1	1	PRIMARY POWER SUPPLY WITH LOCAL RAIL MODULE	3-CAB21B	7165-1657-0186	
		3-BPSM	1	1	BOOSTER POWER SUPPLY WITH LOCAL RAIL MODULE	3-CAB21B	7165-1657-0186	
NODE 11	EST	3-SDDC1	1	1	SINGLE SIGNATURE DRIVER CONTROLLER	3-CAB21B	7165-1657-0186	
	EST	3-SDDC1	1	1	DUAL SIGNATURE DRIVER CONTROLLER	3-CAB21B	7165-1657-0186	
	EST	3-2A20B	4	4	20 WATT ZONED AUDIO AMPLIFIER	3-CAB21B	7165-1657-0186	
	EST	3-2A40B	5	5	40 WATT ZONED AUDIO AMPLIFIER	3-CAB21B	7165-1657-0186	
	EST	3-3LCD	1	1	LIQUID CRYSTAL DISPLAY MODULE	3-CAB21B	7165-1657-0186	
	EST	3-12IS1GY	1	1	12 SWITCHES WITH 1 GREEN & 1 YELLOW LED PER SWITCH DISPLAY	3-CAB21B	7165-1657-0186	
	EST	3-XFP	2	2	EXTENDER FILLER PLATE	3-CAB21B	7165-1657-0186	
	EST	3-CHAS7	3	3	CHASSIS ASSEMBLY - 7 LOCAL RAIL MODULE SPACES	INCLUDED	7165-1657-0186	
	EST	3-CAB21B	1	1	WALLBOX	INCLUDED	7165-1657-0186	
	EST	3-CAB21D	1	1	INNER & OUTER DOORS FOR WALLBOX	3-CAB21B	7165-1657-0186	
BATT	EST	3-RCC14R	1	1	BATTERY CABINET	INCLUDED	7165-1657-0186	
	EST	3-BATS	1	1	BATTERY SHELF	3-RCC14R	-	
	EST	12V50A	2	2	50AH BATTERY	3-RCC14R	-	
	EST	3-RCC2EQ-50	1	1	EARTHQUAKE BRACE FOR 50AH BATTERY	3-RCC14R	-	
	CE AUTO ELECTRIC	ATC7.5	1	1	7.5A ATC FUSE	3-RCC14R	-	
	CE AUTO ELECTRIC	FPATC3	2	2	3-POSITION ATC FUSE PANEL W/POWER DISTRIBUTION	3-RCC14R	-	
	FRNT	EST	PT-1S	1	SERIAL PRINTER	-	7165-1657-0186	
	GFOR	EST	3-ANNCPU3	1	1	FAN CONTROL PANEL CENTRAL PROCESSING UNIT	RSF-L-GR-GP4	7120-1657-0193
		EST	3-EVFWRA	1	1	ANNUNCIATOR POWER SUPPLY CARD	RSF-L-GR-GP4	7120-1657-0199
		EST	3-EVDVRA	2	2	LED / SWITCH DRIVER MODULE	RSF-L-GR-GP4	7120-1657-0199
GSFA	EST	3-EVDVRX	1	1	PLASTIC MOUNTING EXTRUSION FOR EVDVRA	RSF-L-GR-GP4	7120-1657-0199	
	HR KIRKLAND	RSF-L-GR-GP4	1	1	CABINET - 30"W x 41.63"H x 41.75"D	INCLUDED	7120-1178-0100	
	EST	3-ANNCPU3	1	1	GRAPHIC ANNUNCIATOR CENTRAL PROCESSING UNIT	RSQ-GR-GP4	7120-1657-0193	
	EST	3-EVFWRA	1	1	ANNUNCIATOR POWER SUPPLY CARD	RSQ-GR-GP4	7120-1657-0199	
	EST	3-EVDVRA	2	2	LED / SWITCH DRIVER MODULE	RSQ-GR-GP4	7120-1657-0199	
	EST	3-EVDVRX	3	3	PLASTIC MOUNTING EXTRUSION FOR EVDVRA	RSQ-GR-GP4	7120-1657-0199	
	HR KIRKLAND	RSQ-GR-GP4	1	1	CABINET - 52.5"W x 41"H x 41.75"D	INCLUDED	7120-1178-0100	
	FAA	EST	3-1CDANN	1	1	REMOTE LCD ANNUNCIATOR	3-6ANN1B	7120-1657-0193
		EST	3-6ANN1B	1	1	WALLBOX	INCLUDED	7120-1657-0193
		EST	3-CPUDR	2	2	2 BLANK PLATES FILLER PLATES	3-6ANN1B	-
FAA	EST	3-6ANN	1	1	SIX POSITION BASE ANNUNCIATOR INCLUDES (2) 3-ANN5M, (5) BLANK FILLER PLATES, CPU, DISPLAY & DOOR	3-6ANN	7120-1657-0193	
	EST	3-6ANN1B	1	1	WALLBOX	INCLUDED	7120-1657-0193	
	EST	3-ANNCPU3	1	1	ANNUNCIATOR CENTRAL PROCESSING UNIT	3-6ANN	7120-1657-0193	
	EST	3-ANN5M	1	1	ANNUNCIATOR SUPPORT MODULE	3-6ANN	7120-1657-0193	
	EST	3-63S1GYR	3	3	6 GROUPS OF 3 SWITCHES: 1 GRN, 1 YLW, 1 RED LED PER SWITCH	3-6ANN	7165-1657-0193	
	FAA	EST	3-6ANN	1	1	SIX POSITION BASE ANNUNCIATOR INCLUDES (2) 3-ANN5M, (5) BLANK FILLER PLATES, CPU, DISPLAY & DOOR	3-6ANN	7120-1657-0193
		EST	3-6ANN1B	1	1	WALLBOX	INCLUDED	7120-1657-0193
		EST	3-ANNCPU3	1	1	ANNUNCIATOR CENTRAL PROCESSING UNIT	3-6ANN	7120-1657-0193
	P	EST	3-ANNCPU3	1	1	ANNUNCIATOR CENTRAL PROCESSING UNIT	3-6ANN	7120-1657-0193
		EST	3-3LCD	1	1	LIQUID CRYSTAL DISPLAY MODULE	3-6ANN	7120-1657-0193
EST		3-REMIC	1	1	REMOTE MICROPHONE	3-6ANN	7120-1657-0193	
EST		3-12IS1GY	2	2	12 SWITCHES W/ 1 GRN & 1 YLW LED PER SWITCH DISPLAY	3-6ANN	7165-1657-0193	
EST		SIGA-278	97	97	DUAL ACTION MANUAL PULL STATION	4" SQ. DEEP BOX WITH 1 GANG RING	7150-1657-0129	
EST		276B-RSB	5	5	SURFACE MOUNT BOX FOR SIGA PULL STATION	276B-RSB	-	
WP		EST	MPSR1-045W-GE	2	WEATHERPROOF DOUBLE ACTION MANUAL PULL STATION	INCLUDED	7150-1657-0236	
C		EST	SIGA-UI06	3	UNIVERSAL INPUT/OUTPUT MODULE MOTHERBOARD	MFC-A	7300-1657-0121	
		EST	SIGA-UI06R	20	UNI INPUT/OUTPUT MODULE MOTHERBOARD WITH 6 RISER INPUTS	MFC-A	7300-1657-0121	
		EST	SIGA-UI02R	2	UNI INPUT/OUTPUT MODULE MOTHERBOARD WITH 2 RISER INPUTS	MFC-A	7300-1657-0121	
CAB	EST	MFC-A	4	MULTI-FUNCTION FIRE CABINET	INCLUDED	7300-1657-0121		
	EST	3-RCC21R	3	UIO CABINET	INCLUDED	7165-1657-0186		
	UIO	EST	SIGA-MCC1	62	SIGNAL MODULE - UIO MOUNT	MFC-A	7300-1657-0121	
UIO	EST	SIGA-MCR	16	CONTROL RELAY - UIO MOUNT	MFC-A	7300-1657-0121		
UIO	EST	SIGA-MCT2	11	DUAL INPUT MODULE - UIO MOUNT	MFC-A	7300-1657-0121		
C	EST	SIGA-CC1S	18	SYNCHRONIZATION OUTPUT MODULE	4" SQ. DEEP BOX WITH 2 GANG RING	7300-1657-0121		
	EST	SIGA-CR	397	CONTROL RELAY	4" SQ. DEEP BOX WITH 1 GANG RING	7300-1657-0121		
	EST	SIGA-CRH	37	1	HIGH POWER CONTROL RELAY	4" SQ. DEEP BOX WITH 1 GANG RING	7300-1657-0121	
CT	EST	SIGA-CT1	28	SINGLE INPUT MODULE	4" SQ. DEEP BOX WITH 1 GANG RING	7300-1657-0121		
	EST	SIGA-CT2	89	DUAL INPUT MODULE	4" SQ. DEEP BOX WITH 1 GANG RING	7300-1657-0121		
	EST	SIGA-IO	1062	INPUT/OUTPUT MODULE	4" SQ. DEEP BOX WITH 1 GANG RING	7300-1657-0210		
R	SYSTEM SENSOR	PR-1	2530	MULTI-VOLTAGE RELAY	4" SQ. DEEP BOX WITH 1 GANG RING	7300-1653-0172		
	EST	SIGA2-PS SIGA-PD	1777	PHOTO SMOKE DETECTOR	SIGA-SB4	7272-1657-0299 7272-1657-0331		
	EST	SIGA2-PS SIGA-PD	2	PHOTO SMOKE DETECTOR (WALL MOUNTED)	SIGA-SB4	7272-1657-0299 7272-1657-0331		
P	EST	SIGA-SB4	2	4" DETECTOR MOUNTING BASE	4" OCTAGON BOX	7300-1657-0120		
	EST	SIGA2-PS SIGA-PD	3	PENDANT MOUNT PHOTO SMOKE DETECTOR	SIGA-SB4	7272-1657-0299 7272-1657-0331		
	EST	SIGA-SB4	3	4" DETECTOR MOUNTING BASE	4" OCTAGON BOX	7300-1657-0120		
RB	EST	SIGA2-PS SIGA-PD	335	PHOTO SMOKE DETECTOR	SIGA-RB4	7272-1657-0299 7272-1657-0331		
	EST	SIGA-RB4	335	4" DETECTOR MOUNTING BASE WITH RELAY	4" OCTAGON BOX	7300-1657-0120		
	EST	SIGA-PD	93	PHOTO SMOKE DETECTOR	SIGA-SB	7272-1657-0331		
DMP	EST	SIGA-DMP SIGA-SB	93	DETECTOR MOUNTING PLATE DETECTOR MOUNTING BASE	INCLUDED SIGA-DMP	7272-1657-0299 7272-1657-0331		
	EST	SIGA2-HRS SIGA-SB4	252	FIXED TEMP. / RATE-OF-RISE HEAT DETECTOR	SIGA-SB4	7270-1657-0288 7300-1657-0120		
	EST	SIGA2-HFS SIGA2-HRD SIGA-SB4	1	FIXED TEMP. HEAT DETECTOR RATE OF RISE HEAT DETECTOR 4" DETECTOR MOUNTING BASE	SIGA-SB4	7270-1657-0288 7270-1657-0333 7300-1657-0120		
RC	EST	302-EPM-135 JALX-11	7	HEAT DETECTOR - RATE COMP., 135 DEGREE OUTLET BODY WITH COVER	-	7270-0021-0001		
	EST	SIGA-CT1	7	SINGLE INPUT MODULE	4" SQ. DEEP BOX WITH 1 GANG RING	7300-1657-0121		
	EST	302-AW-135	1	WEATHERPROOF HEAT DETECTOR - RATE COMP., 135 DEGREE	7270-0021-0001	-		
WP	EST	SIGA-CT1	1	SINGLE INPUT MODULE	4" SQ. DEEP BOX WITH 1 GANG RING	7300-1657-0121		
	EST	SIGA-SD SD-T4X	96	DUCT SMOKE DETECTOR SAMPLING TUBE	INCLUDED	3242-1657-0223		
	EST	BPSBA 12V6AS	54 108	6.5 AMP BOOSTER POWER SUPPLY 7.2AH BATTERY	INCLUDED	7300-1657-0229		
15CD WP	EST	BPS2EQ	54	EARTHQUAKE BRACE FOR 7.2AH BATTERY	BPS10A	-		
	EST	757-7A-RS70 757A-WB	39	WEATHERPROOF SPEAKER-STROBE 157/5CD (WALL - CEILING) WEATHERPROOF BOX	757A-WB	7125-1657-0181		
	EST	LKC-1	39	LENS KIT	-	-		
110CD WP	EST	757-7A-RS70 757A-WB	13	WEATHERPROOF SPEAKER-STROBE - 110CD WALL, 60CD CEILING WEATHERPROOF BOX	757A-WB	7125-1657-0181		
	EST	LKC-1	13	LENS KIT	-	-		
	EST	GCF-S7 GCHWF-S7	550	CEILING MOUNT SPEAKER	4" SQ. DEEP BOX	7320-1657-0211 7320-1657-0324		
H	EST	G4F-S7 G4HWF-S7	25	WALL MOUNT SPEAKER	4" SQ. DEEP BOX	7320-1657-0323		
	EST	G4B	10	SURFACE MOUNT BOX FOR WALL MOUNT SPEAKER	G4B	7320-1657-0323		
	EST	G4F-S7VM G4HFW-S7VMC	127	WALL MOUNT SPEAKER-STROBE (15, 30, 75, 110 SELECTABLE CANDELA OUTPUT)	4" SQ. DEEP BOX	7320-1657-0211 7320-1657-0323		
H	EST	GCF-S7VM GCHFW-S7VMC	1350	CEILING MOUNT SPEAKER-STROBE (15, 30, 75, 95 SELECTABLE CANDELA OUTPUT)	4" SQ. DEEP BOX	7320-1657-0211 7320-1657-0324		

				SYMBOL LEGEND			
SYM.	MFG.	MODEL #	TOTAL QTY.	ASU ADD T1 QTY.	DESCRIPTION	BACKBOX	CSFM
	EST	GCF-STVM GCHFVF-STVMC	1350		CEILING MOUNT SPEAKER-STROBE (15, 30, 75, 95 SELECTABLE CANDELA OUTPUT)	4" SQ. DEEP BOX	7320-1657-0211 7320-1657-0324
	EST	GCF-STVMH GCHFVF-STVMCH	12		CEILING MOUNT SPEAKER-STROBE (95, 115, 150, 177 SELECTABLE CANDELA OUTPUT)	4" SQ. DEEP BOX	7320-1657-0211 7320-1657-0324
	EST	G1F-VM	3		WALL MOUNT STROBE (15, 30, 75, 110 SELECTABLE CANDELA OUTPUT)	SINGLE GANG	7125-1657-0218
	EST	GCF-VM	159		CEILING MOUNT STROBE (90, 75, 95 SELECTABLE CANDELA OUTPUT)	4" SQ. DEEP BOX	7125-1657-0218
	EST	GCF-VMH	25		CEILING MOUNT STROBE (95, 115, 150, 177 SELECTABLE CANDELA OUTPUT)	4" SQ. DEEP BOX	7125-1657-0219
	EST	8633-4	132		FIREFIGHTERS TELEPHONE JACK	SINGLE GANG	6912-1657-0137
	EST	8633-3	6		TELEPHONE HANDET ASSEMBLY	8632-1	6912-1657-0137
		TSC-6	1		WALLBOX	-	-
	ATLAS SOUNDOLIER	AT35-PA	1		ATTENUATOR WITH PRIORITY PAGING	-	-
	BY OTHERS	-	173		DOOR HOLDER	-	-
	BY OTHERS	-	335		DOME LIGHT	-	-
	BY OTHERS	-	1		120V WATERFLOW BELL	-	-
	BY OTHERS	-	6		ANSUL EXTINGUISHING SYSTEM	-	-
	BY OTHERS	-	1		PRE-ACTION CONTROL PANEL	-	-
	BY OTHERS	-	13		FM-200 CONTROL PANEL	-	-
	BY OTHERS	SSU00653 / TCX D 128	13		TCX D 128 POINT TERMINAL CABINET	INCLUDED	7300-0553/0110
	BY OTHERS	-	1043		FIRE/SMOKE DAMPER	-	-
	BY OTHERS	-	46		WATERFLOW SWITCH	-	-
	BY OTHERS	-	47		VALVE TAMPER SWITCH	-	-
	BY OTHERS	-	8		ISOLATION VALVE	-	-
	POTTER	RMS-1T-LP YELLOW "EMERGENCY" DOOR RELEASE"	1		STAIRWELL LOCK RELEASE STATION	SINGLE GANG	7150-1039/0101
	EST	SIGA-CT1	1		SINGLE INPUT MODULE	4" SQ. DEEP BOX WITH 1 GANG RING	7300-1657-0121
	EST	MFC-A	1		MULTI-FUNCTION FIRE CABINET	INCLUDED	7300-1657-0121
	EST	MN-BRKT2	1		MOUNTING BRACKET	MFC-A	7165-1657-0186
	EST	MN-QOM1S	2		COMMUNICATION INTERFACE MODULE	MFC-A	7165-1657-0186
	EST	FW-JUL6W	1		FIREWORKS CPU	-	7300-1657-0213
	EST	FW-22LCDWTS	1		22" TOUCH SCREEN LCD WITH INTEGRAL SPEAKERS	-	7300-1657-0213
	EST	FW-CGSUL	1		FIREWORKS SOFTWARE PACKAGE	-	-
	EST	3-RS232	1		RS-232 COMMUNICATION CARD	-	7300-1657-0186
	EST	SIGA-MP1	1		MODULE MOUNTING PLATE - 2 ROW	-	-
	EST	SIGA-MP2	18		MODULE MOUNTING PLATE - 1 ROW	-	-

VNGC CABLE LEGEND									
DES.	MFG.	PART NUMBER	DESCRIPTION	AWG	CONDUCTOR	STYLE	TYPE	UL LISTED	T-TAPS
A	LAKE CABLE	P162F	DATA	16	2	TWISTED	PLENUM RATED FPLP	FPLP/CMF	YES, PER AGREEMENT (MAX. 124)
AA	LAKE CABLE	162F	DATA	16	2	TWISTED	NON-PLENUM RATED FPLR	FPLR/CMR	YES, PER AGREEMENT (MAX. 124)
B	LAKE CABLE	P122F	VISUAL NAC	12	2	TWISTED	PLENUM RATED FPLP	FPLP/CMF	NO
DM	LAKE CABLE	P162F	DOME LAMP	16	2	TWISTED	PLENUM RATED FPLP	FPLP/CMF	NO
F	LAKE CABLE	P142FS	FIREFIGHTER'S PHONE	14	2	TWISTED SHIELDED	PLENUM RATED FPLP	FPLP/CMF	NO
FR	LAKE CABLE	142FS	FF'S PHONE RISER	14	2	TWISTED SHIELDED	NON-PLENUM RATED FPLR	FPLR/CMR	NO
NA	LAKE CABLE	162FS	NETWORK AUDIO	16	2	TWISTED SHIELDED	NON-PLENUM RATED FPLR	FPLR/CMR	NO
ND	LAKE CABLE	162F	NETWORK DATA	16	2	TWISTED	NON-PLENUM RATED FPLR	FPLR/CMR	NO
P	N/A	N/A	24VDC POWER	12	2	THHN	THHN	THHN	YES
PRN	LAKE CABLE	224C	PRINTER	22	4	TWISTED	NON-PLENUM RATED FPLR	FPLR/CMR	NO
RA	LAKE CABLE	142FS	REMOTE AUDIO	14	2	TWISTED SHIELDED	NON-PLENUM RATED FPLR	FPLR/CMR	NO
RK	LAKE CABLE	142F	REMOTE MIC KEY	14	2	TWISTED	NON-PLENUM RATED FPLR	FPLR/CMR	NO
S	LAKE CABLE	P142FS	SPEAKER	14	2	TWISTED SHIELDED	PLENUM RATED FPLP	FPLP/CMF	NO
SR	LAKE CABLE	142FS	SPEAKER RISER	14	2	TWISTED SHIELDED	NON-PLENUM RATED FPLR	FPLR/CMR	NO
M	LAKE CABLE	162F	SPARE	16	2	TWISTED	NON-PLENUM RATED FPLR	FPLR/CMR	NO

SCOPE OF WORK

Fire Alarm Vendor

converⁱnt

5860 W Las Positas Blvd Ste 7, Pleasanton, CA. 94588
Phone: (510) 300-2800 Fax: (925) 225-1101
C10 License No: 986407

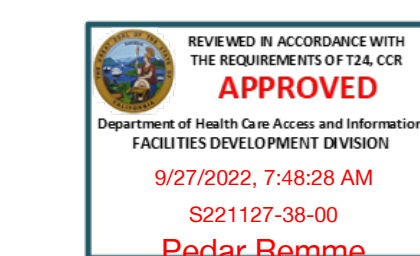
SKA Project Number

2219

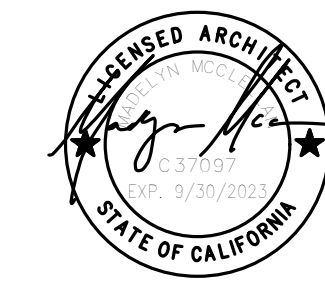
HCAI Num

S221127-38-00

HCAI seal/signature



Seal/Signature



Issued for

HCAI PLAN REVIEW

[illegible]

Drawn by

Checked by _____

Project Name

4TH FLOOR ACU AUTOMATIC DOOR OPERATORS

Sheet Title

FIRE ALARM PLAN LEGENDS

Date _____

Scale

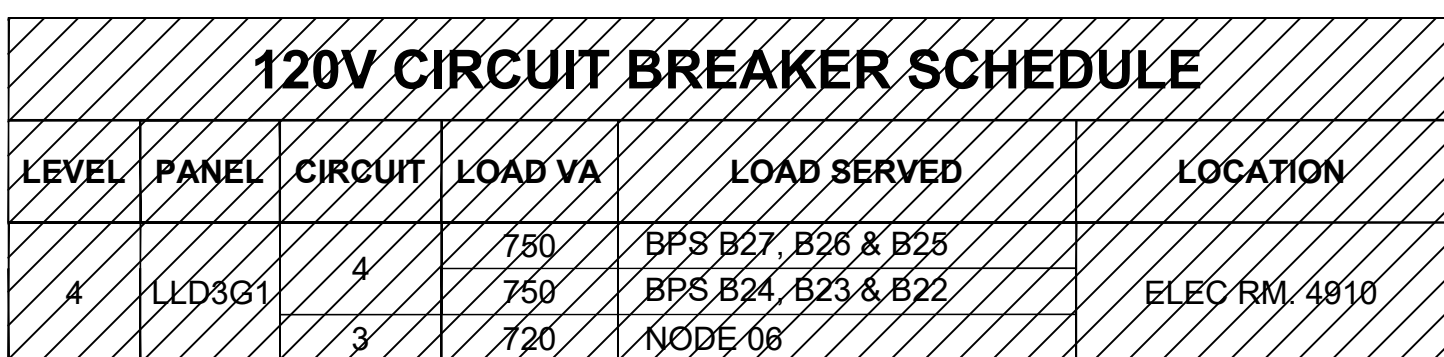
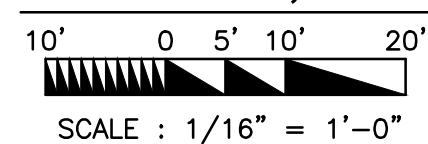
Sheet Number

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FA.0.02

OPENING NUMBER	FIRE RATING (MINUTES)	% SELF CLOSING	AUTOMATIC CLOSING - MHO SECURITY DEVICE (CF)	DELAYED EGRESS	AUTOMATIC DOORS	HW GROUP	FAIL SAFE (FS) OR FAIL SECURE (FSE) TIE INTO FA	LEVEL / FLOOR	COMMENTS	ROOM	FIRE ALARM DESCRIPTION #
P3100-C	90S					30A	FS 1 P3			Elevator Lobby	1
P3100-A	2		03	FS 1 P3						Elevator Lobby	8
P3300-A	S		1	01	FS 1 P3					Elevator Lobby	10
P2100-A	2		2	03	FS 1 P2					Elevator Lobby	8
P2300-A	1		1	01	FS 1 P2					Elevator Lobby	8
S106-A	90S	1	1	6A	FS 1 1					Stair #6	1
C140-A	45S	2	1	42	FSE 1 1					Corridor	2
C152-A	45S	2	1	2	42B	FSE 1 1				Hallway	2
C151-A	45S	2	1	2	42A	FSE 1 1				Hallway	2
1604-A	S	1		126	FS 1 1					Secure Drop Off	5
1050-A	45S	2		18	FS 1 1					Elevator Lobby	2
1051-A	45S	2	1	2	40	FSE 1 1				Storage, Medical Equipment	2
1060-A	45S	1	1							Elevator Lobby	2
1060-B	45S	2		147	FS 1 1					Elevator Lobby	5
1061A-A	20S	1		1	02	FS 1 1				Toilet Patient	8
1210-A	1		1	01	FS 1 1					Toilet Patient	8
1522-B	45S	1	1	1	45	FSE 1 1				Workroom, Dish Potwash	2
1323-B	45S	1	1	1	45B	FSE 1 1				Anteroom	2
1340-A	2		1	1	1	1			Mag Lock	Technology Room	7
X1 000-B	-	1	1	2	2A	FS 1 1			Besam SL500, Mag Lock	Lobby	-
S202-A	20S	1	1	6A	FS 1 2					Stair #2	1
S203-A	90S	1	1	6A	FS 1 2					Stair #3	1
S205-A	90S	1	1	6A	FS 1 2					Stair #5	10
2920-A	60S	1		2	FS 1 2					Lobby	1
C291-A	45S	2		17A	FS 1 2					Corridor	5
C228-A	S	1		2	FS 1 2					Elevator 24 (Corridor)	11
C225-A	20S	2		19	FS 1 2					Corridor	5
2050-A	45S	2		147A	FS 1 2					Elevator Lobby	5
2200-B	S	2	1	2	40A	FSE 1 2				Bulk Stores and Receiving	2
2240-B	S	2	1	2	42A	FSE 1 2				Storage, EVS	2
2600-A	60S	1		2	FS 1 2					Seating Cafe	11
2620-A	45S	2		2	FS 1 2				Rated Storefront	Dining, Cafeteria	3
2450-B	20S	1		121	FS 1 2					Workroom, Cashier	6
2232-B	S	1		2	FS 1 2					Elevator 23, Soil Group 7	10
2338-A	S	1		2	FS 1 2					Elevator 21 Clean Group 6	10
2338-B	S	1		2	FS 1 2					Elevator 22 Clean Group 6	10
2810-A	45S	1		1	05	FS 1 2				Elevator Lobby	8
2834-A	20S	1		1	04	FS 1 2				Toilet Patient	8
2936-A	20S	1		1	04	FS 1 2				Toilet Patient	8
X2 013-A	-	1		2	2A	FS 1 2			Besam SL500, Mag Lock	Lobby	3
S302-A	20S	1	1	6A	FS 1 3					Stair #2	1
S306-A	20S	1	1	6A	FS 1 3					Stair #6	1
C360-A	2		1	2	20	FSE 1 3				Corridor	2
C361-A	45S	2		2	86	FS 1 3				Hallway	3
C305-B	90S	2	1	2	20	FS 1 3				Corridor	2
C392-A	-	2	1	2	22A	FS 1 3			Mag Lock	Corridor	2
C392-B	45S	2	1	2	22A	FS 1 3			Mag Lock	Corridor	2
C395-A	20S	2	1	2	22A	FS 1 3			Mag Lock	Corridor	2 & 5
C331-A	-	2	1	2	20	FSE 1 3				Hallway	5
C333-A	-	2	1	2	19	FS 1 3				Hallway	5
C334A-A	45S	2		66	FS 1 3					Corridor	5
C334A-B	-	2	1	2	20	FSE 1 3				Corridor	2
C334A-C	45S	2		19	FS 1 3					Corridor	5
C332-A	45S	2		17	FS 1 3					Hallway	5
C333A-A	45S	2		17	FS 1 3					Hallway	5
C350-A	45S	2		2	86	FS 1 3				Corridor	3
C350-B	20S	2		19	FS 1 3					Corridor	5
C352-A	45S	1		1	46	FS 1 3				Hallway	3
C351A-A	90S	2		2	22	FS 1 3				Corridor	3
C353-A	45S	1		1	46	FS 1 3				Hallway	3
C355-A	45S	2		17	FS 1 3					Hallway	5
C338A-A	45S	2		17	FS 1 3					Hallway	5
3050-A	20S	2		18	FS 1 3					Elevator Lobby	5
3050-B	S	1		2	FS 1 3					Elevator Lobby	10
3050-C	S	1		2	FS 1 3					Elevator Lobby	10
3050-D	S	1		2	FS 1 3					Elevator Lobby	10
3050-E	S	1		2	FS 1 3					Elevator Lobby	10
3200-A	90S	2	1	2	20B	FS 1 3				Lobby	2
3220-B	-	2		2	42	FSE 1 3				Holding, Recycling, Cardboard	3
3308-A	45S	2		17A	FS 1 3					Waiting, Pediatric	5
3301-A	S	1		2	FS 1 3					Lobby	10
3060-A	20S	2		18	FS 1 3					Elevator Lobby	5
3900-A	60S	1		2	FS 1 3					Elevator Lobby	11
3900-B	45S	2		2	FSE 1 3					Elevator Lobby	3
3510-A	45S	2		2	12A	FSE 1 3				Hold, Patient	3
3509-A	20S LL	2		2	75A	FSE 1 3				CT Scan	3
3503-A	20S LL	2		2	75A	FSE 1 3				CT Scan	3
3501-A	20S LL	2		2	75E	FSE 1 3				CT Scan	3
3590-A	45S	2		2	75	FSE 1 3				Vestibule, MRI	3
3559-A	20S LL	1		1	138	FSE 1 3				Fluoroscopy	3
3555-A	20S LL	1		1	138A	FSE 1 3				Radiology/Fluoroscopy	3
3553-A	20S LL	1		1	138	FSE 1 3				Radiology, General X-ray	3
3551-A	20S LL	1		1	138	FSE 1 3				Radiology, General X-ray	3
3399-A	S	1		97B	FS 1 3					Holding, Patient Observe Care	5
3306-A	20S	1		1	02	FS 1 3				Toilet Patient	8
3395-A	20S	1		1	02	FS 1 3				Toilet Patient	8
3811-A	20S	1		1	04	FS 1 3				Toilet Public Female	8
3813-A	20S	1		1	04	FS 1 3				Toilet Public Male	8
3848-A	20S	1		1	02	FS 1 3				Toilet Public	8
X3 321-A	45S	2		2	2A	FS 1 3			Besam SL500, Mag Lock	Lobby	3
S402A-A	90S	1	1	6B	FS 1 4					Stair #2	1
S404A-A	90S	1	1	6B	FS 1 4					Stair #4	1
S408A-A	90S	1	1	6B	FS 1 4					Stair #8	1
C412-A	45S	2	1	2	20	FS 1 4				Hallway	2
C413-A	20S	2		19	FS 1 4					Corridor	5
C413-B	20S	2	1	2	23A	FS 1 4				Corridor	2
C411A-A	-	2		19	FS 1 4					Corridor	5
C411A-B	45S	2	1	2	20	FS 1 4				Corridor	2
C411A-C	45S	1		106A	FS 1 4				Delayed Egress Hardware	Corridor	9
C401-A	45S	1		106	FS 1 4				Delayed Egress	Hallway	9
C404-A	90S	2	1	1	23	FS 1 4			Delayed Egress	Corridor	9
C426-A	45S	2		2	86	FSE 1 4				Hallway	3
C426-B	45S	2		2	86	FS 1 4				Hallway	3
C432-A	20S	2	1	2	23C	FS 1 4				Corridor	3
C406-A	45S	2		19A	FS 1 4					Corridor	5
C407-A	90S	2		19	FS 1 4					Corridor	5
C441-A	90S	2		2	86	FSE 1 4				Hallway	3
C441-B	45S	1		02	FSE 1 4					Hallway	9
C441-C	45S	2		2	86	FSE 1 4				Hallway	3
C460C-A	-	2		19	FS 1 4					Corridor	5
C460A-A	20S	2		19	FS 1 4					Hallway	5
C451-A	20S	2	1	2	23A	FS 1 4				Corridor	2
C433-A	90S	2		19	FS 1 4					Corridor	5
C433-B	20S	2		19	FS 1 4					Corridor	5
C461-A	20S	2	1	2	20	FSE 1 4				Corridor	2
C482-A	20S	2		19	FS 1 4					Corridor	5
C437-A	20S	2	2	19	FS 1 4					Corridor	5
C438A-A	20S	2	2	2	23A	FSE 1 4				Corridor	2
C415.2-A	20S	2		146	FS 1 4					Electronics	2
4156-A	20S	2		2	75	FSE 1 4				Procedure Room, Fluoro	3
4134-A	20S	2		2	75	FSE 1 4				Procedure, Fluoro	3
4131-A	20S	1		1	02	FS 1 4				Toilet Public	8
4130-A	20S	2		2	75A	FSE 1 4				Procedure, Fluoro	3
4050-A	20S	2	1	2	20	FSE 1 4				Elevator Lobby	2
4348-A	20S	2		99	FS 1 4					Storage, Imaging	5
4300F-A	45S	2		2	75B	FSE 1 4				Recovery, PACU	3
4300F-B	45S	2	1	2	20	FSE 1 4				Recovery, PACU	2
4300G-A	45S	2		2	12A	FSE 1 4				Recovery, PACU	3
4060-A	45S	2	2	2	20	FS 1 4				Elevator Lobby	2
C430-A	45S	2	1	2	20	FSE 1 4				Hallway	2
4348-B	20S	1		121	FS 1 4					Control Station	6
4900-A	60S	1		2	FS 1 4					Elevator Lobby	11
4617-A	20S	2		2	75C	FSE 1 4				Procedure, Cardiac, Cath	3
4611-A	20S	2		2	75C	FSE 1 4				Procedure, Interventional Radiology	3
4616-A	20S	2		2	75D	FSE 1 4				Procedure, Cardiac, Cath	3
4612-A	20S	2		2	75C	FSE 1 4				Procedure, Interventional Radiology	3
4529-A	20S	2		100	FS 1 4					Storage, Imaging	5

DOOR DESCRIPTIONS FOR FIRE ALARM INTERFACE APPLICATION	
1	3 IN 1 CARD READER CONNECTED TO THE FIRE ALARM SYSTEM ON ONE SIDE OF A SINGLE DOOR TIED TO AN ELECTRONIC LOCKING MECHANISM (FAIL SAFE) WITH PANIC HARDWARE ON THE EGRESS SIDE OF THE DOOR. STAIRWELL DOORS ARE TYPICAL OF THIS DOOR TYPE.
2	CONTROLLED BY AN INDIVIDUAL CONTROL RELAY TO INTERRUPT THE POWER SUPPLY FEEDING THE LOCKING MECHANISM FOR ALL DOORS TIED TO THE POWER SOURCE TO ALLOW ACCESS TO FIRE PERSONNEL DURING A FIRE EVENT.
2	CARD READER AND A MOTORIZED DOOR OPERATOR
2	CONTROLLED BY AN INDIVIDUAL RELAY TO SHUNT THE TIMING MECHANISM AND SHUT THE DOOR IMMEDIATELY WITHOUT ANY TIME DELAY. RELAY WILL ALSO DE-ACTIVATE THE PUSH PLATE, NOT ALLOWING THE DOOR TO OPEN AND SERVE TO BY-PASS THE CARD READER SECURITY ON THE DOOR FOR FIRE DEPARTMENT ACCESS DURING AN EVENT.
2	MOTORIZED DOOR OPERATORS (NO CARD READER) ON A SINGLE OR DOUBLE DOOR(S)
5	CONTROLLED BY AN INDIVIDUAL RELAY TO REMOVE THE TIMING MECHANISM AND CLOSE THE DOOR(S) IMMEDIATELY WITHOUT ANY TIME DELAY, AS WELL AS DE-ACTIVATE THE PUSH PLATE (S), NOT ALLOWING THE DOOR(S) TO OPEN
4	CARD READER WITH NO MOTORIZED DOOR OPERATOR
1	CONTROLLED BY AN INDIVIDUAL RELAY TO BY-PASS THE CARD READER SECURITY AND RELEASE THE DOORS INTO THE SECURE AREA FOR FIRE DEPARTMENT ACCESS.
5	MAGNETIC DOOR HOLDER
2	CONTROLLED VIA A COMMON RELAY LOCATED IN THE ELECTRICAL ROOM TO DROP ALL DOORS ON THE FLOOR OF EVENT.
6	FIRE SHUTTERS / OVERHEAD DOOR/ COILING DOORS
2	CONTROLLED BY AN INDIVIDUAL RELAY AT THE FIRE SHUTTER TO RELEASE ON THE FLOOR OF EVENT.
7	MAG LOCK ON TECHNOLOGY ROOM DOOR
5	CONTROLLED BY AN INDIVIDUAL OR A COMMON RELAY TO RELEASE ON FLOOR OF EVENT.
8	DELAYED EGRESS DOOR WITH CARD READER(S) (POSSIBLE PUSH PLATE OR CARD READER ON OPPOSITE SIDE FOR AUTOMATIC DOOR OPERATION). THE DOOR SET HAS A MOTORIZED OPERATOR THAT IS TRIGGERED BY EITHER CARD READER OR A PUSH PLATE TO OPEN THE DOOR FOR A PRE-SET TIME. PANIC HARDWARE ON A NON-SECURED SIDE ALLOWS IMMEDIATE EGRESS, WHILE THE DELAYED EGRESS SIDE INITIATES THE 16 SECOND ALARMED DELAY.
1	CONTROLLED BY TWO PILOT RELAYS; ONE TO SHUNT THE PUSH PLATE AND/OR TIMING MECHANISM, SHUTTING THE DOOR IMMEDIATELY, AS WELL AS DE-ACTIVATING THE PUSH PLATE, NOT ALLOWING THE DOOR TO OPEN. THE SECOND RELAY WILL SERVE TO DROP POWER TO THE DELAYED EGRESS DOOR ALLOWING IMMEDIATE EXITING AND FIRE DEPARTMENT ACCESS.
9	DELAYED EGRESS AT A VESTIBULE DOOR WITH CARD READER ON THE SECURED SIDE OF A SINGLE DOOR. PANIC HARDWARE EXISTS TO ALLOW EGRESS TO THE STAIRWELL DOOR AFTER THE FIFTEEN SECOND DELAYED EGRESS ALARMED DELAY. THE CARD READER FUNCTION IS TO BY-PASS THE DELAYED EGRESS SECURITY AND ALLOW ENTRY INTO THE VESTIBULE.
10	CONTROLLED BY AN INDIVIDUAL RELAY TO DROP POWER TO THE MAGNETIC LOCK FOR ENTRY INTO THE VESTIBULE AND FOR FIRE DEPARTMENT ACCESS DURING AN EVENT.
10	SMOKE CURTAIN/GUARD
1	CONTROLLED BY A COMMON RELAY FOR AN ELEVATOR DOOR OPENING. SMOKE CURTAIN RELEASE IS TRIGGERED BY THE ELEVATOR SMOKE DETECTOR.
11	ACCORDION FIRE AND SMOKE RATED DOOR
1	CONTROLLED BY A SINGLE RELAY FOR LARGE OPENING ACCORDION DOOR
12	ALL DELAYED EGRESS DOORS SHALL UNLOCK ON ACTIVATION OF AUTOMATIC ALARMS (SMOKE DETECTORS, HEAT DETECTORS, AND WATER FLOW SWITCHES) AND LOSS OF POWER AT ANY OF THE PRIMARY FIRE ALARM NODES. STAIRWAY DELAYED EGRESS DOORS SHALL UNLOCK ON ACTIVATION OF THE YELLOW PULL STATION IN THE FOC. ALL OTHER DELAYED EGRESS FUNCTIONS ARE BY OTHERS. SEE CBC 1008.1.6 FOR DETAILS.
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OCCUPANCY CLASS
I-2 FLOOR CONFIGURED FOR DELAYED EGRESS

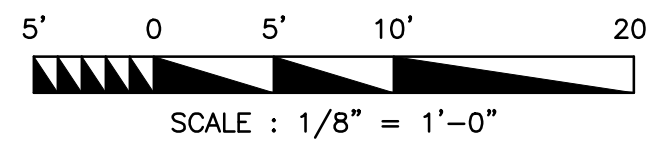
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30 X 42

LEVEL 4, ZONE 1 - DEVICE LAYOUT

NOTE: ALL FIRE/SMOKE DAMPERS OPERATE VIA AREA SMOKE DETECTION.
DOOR HOLDERS RELEASE UPON ANY ALARM EVENT ON A PER FLOOR BASIS.



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<

FIRE/SMOKE DAMPER DESIGNATION

LEVEL
AJU

FSD NUMBER

FSD-XXXXXX
XXXXXXX

INPUT/OUTPUT
MODULE ADDRESS

ADDRESS CIRCUIT LEGEND

LRM CARD#

PANEL #

PPCCDDDD

DEVICE ADDRESS#

STROBE CIRCUIT LEGEND

STROBE

POWER SUPPLY #

CIRCUIT #

DEVICE #

SX X#

(X# DESIGNATES NODE)

AUDIO/PHONE JACK CIRCUIT LEGEND

SIGNAL TYPE
(A, F)

CIRCUIT #

DEVICE #

A = AUDIO (SPEAKER)
F = FIREFIGHTER'S PHONE JACK

KEYED SHEET NOTES



①	CONTROL RELAY FOR ELEVATOR RECALL RELEASE.	⑩	FIRE/SMOKE DAMPER OR FAN OPERATES VIA AREA SMOKE DETECTION.	⑳	STAIR DOOR LOCK CONTROLLED VIA CONTROL RELAY IN TECHNOLOGY ROOM.
②	CONTROL RELAY FOR ELEVATOR ALTERNATE RELEASE.	⑪	ARELW FOR DUCT SMOKE DETECTOR SHALL MEET MANUFACTURER'S SUGGESTED SPECIFICATIONS.	㉑	CONTROL RELAY FOR AV SYSTEM SHUTDOWN.
③	CONTROL RELAY FOR FIREMANS HOT SIGNAL.	⑫	MOUNT PLenum MOUNT SMOKE DETECTOR WITHIN 12 INCHES OF DAMPER. SEE DETAIL FOR PENDANT MOUNT SMOKE DETECTOR INSTALLATION DETAIL ON SHEET F.A.14.	㉒	MONITOR MODULE FOR RATE OF TEMPERATURE HEAT DETECTION.
④	CONTROL RELAY FOR ELEVATOR POWER SHUNT TRIP.	⑬	MOUNT DUCT SMOKE DETECTOR UPSTREAM AND WITHIN 3 FEET OF SMOKE DAMPER. SEE DETAIL ON SHEET F.A.14. ARELW FOR DUCT SMOKE DETECTOR SHALL MEET MANUFACTURER'S SUGGESTED SPECIFICATIONS.	㉓	SEE DETAIL F.A.0.1 ON SHEET F.A.4 FOR W/IRING ON RAIL AND RESPONDER IN RUSH CALL SYSTEM. SEE W/IRE DESIGNATION ON SHEET F.A.0.0 FOR W/IRING FOR THE FIRE BASE SMOKE DETECTOR TO THE DOME LIGHT.
⑤	MONITOR MODULE FOR SHUNT TRIP POWER SUPERVISION. FIELD VERIFY LOCATION.	⑭	SMOKE DETECTOR AS SHOWN IN THE "SMOKE DETECTOR FOR DUCT CONTROL" DETAILATION DETAIL ON SHEET F.A.14.	㉔	ONE OF TWO STAYW/IRE SMOKE DETECTOR. AN ACCESSIBLE UL LISTED SMOKE DETECTOR TO BE PROVIDED BY OTHERS. SEE ELEVATOR HOISTWAY SMOKE DETECTOR DETAILATION DETAIL ON SHEET F.A.0.1.
⑥	CONTROL RELAY FOR MAGNETIC DOOR HOLDER CONTROL. FIELD VERIFY LOCATION.	⑮	MONITOR MODULE FOR ELEVATOR MACHINE ROOM/REGULATIVE SHUNT TO BE LOCATED 2 FEET FROM SWINGER DEAD.	㉕	MONITOR MODULE FOR YELLOW STAIRWELL LOCK RELEASE STATION. SEE DOOR SCHEDULE FOR ADDITIONAL INFORMATION.
⑦	CONTROL RELAY FOR SECURITY INTERFERENCE DETECTION. FIELD VERIFY LOCATION IN FSC. SEE DOOR SCHEDULE ON SHEET F.A.0.0 FOR MORE INFORMATION. SEE SECURITY DRAWINGS FOR WIRING DIAGRAM.	⑯	MONITOR MODULE FOR FIREMANS AIR FILLING STATION. LOW AIR PRESSURE SUPERVISION.	㉖	RELAY MODULE FOR LIGHTING CONTROL.
⑧	CONTROL RELAY FOR ELEVATOR SMOKE GUARD. MONITOR FIELD VERIFY LOCATION.	⑰	DEVICES EXPOSED TO THE OUTSIDE ENVIRONMENT SHALL BE MOUNTED IN A WEATHER PROOF ENCLOSURE.	㉗	DELAY EGRESS DOOR.
⑨	NOT USED.	⑱	SMOKE DETECTOR FOR STAIR PRESSURIZATION CAN BE FORMED AS THOSE SHOWN IN THE PAGING SYSTEM FOR WIRING.	GENERAL SHEET NOTE	
⑩	CONTROL RELAY FOR FAN SHUTDOWN.	⑲	MONITOR FIRE OR COMBINATION MODULE/STROBE IN SLEEPING AREA WITHIN 46 FEET OF THE PILLOW PER APPA 72.2.		
⑪	INPUT/OUTPUT MODULE FOR FIRE/SMOKE DAMPER CONTROL AND STATUS.	㉑	MONITOR MODULE FOR WATER TANK HIGH/Low SUPERVISION. FIELD VERIFY LOCATION.	1.	THE FIRE ALARM SYSTEM HAS ALSO BEEN DESIGNED TO BE USED AS THE PAGING SYSTEM. ANY FIRE ALARM MESSAGE WILL OVERRIDE A PAGING ANNOUNCEMENT.
⑫	INPUT/OUTPUT MODULE FOR FAN ON STATUS AND FAN OVERSPEED.	㉒	MONITOR MODULE FOR ANSUL SYSTEM ALARM AND PROBLEMS WITH SUPPLY.	2.	FIRE ALARM WIRING WILL NOT BE INSTALLED IN CONDUIT UNLESS WIRING TO DEVICES INITIATING / INTERACTING WITH STAIR PRESSURIZATION OR UNLESS OTHERWISE NOTED.
⑬	MONITOR MODULES FOR EMERGENCY GENERATOR POWER SUPPLY. FIELD VERIFY LOCATION. SEE TROUBLE & FUEL LEAK.	㉓	SEE RISER DIAGRAM FOR WIRE CONNECTIONS.	3.	PENETRATIONS THRU WALLS REQUIRING PROTECTED PENETRATIONS SHALL BE PROTECTED BY ANOTHER MATERIAL SHALL BE A UL LISTED ASSEMBLY. INSTALLED ACCORDING TO THE MANUFACTURER'S INSTRUCTIONS. SEE DETAIL F.A.0.1 FOR "THROUGH PENETRATIONS FIRESTOP" BINDER FOR INFORMATION AND DETAILS.
⑭	MONITOR MODULES FOR LOW FLOW SUPERVISION. MONITOR CHARGE WATER TANK. SEE TROUBLE & FUEL LEAK.	㉔	RELAY FOR DOOR CONTROL. SEE DOOR SCHEDULE ON SHEET F.A.0.0 FOR MORE INFORMATION.		
⑮	MONITOR MODULE FOR FAN POWER SUPERVISION. MONITOR WIND ON CONTACTS AT LAST DISCONNECT CONTACTS PROVIDED BY OTHERS.				

Fire Alarm Vendor

convergent

5860 W Las Positas Blvd Ste 7, Pleasanton, CA. 94588
Phone: (510) 300-2800 Fax: (925) 225-1101
C10 License No: 986407

Seal/Signature

Issued for
HCAI PLAN REVIEW

Drawn by	KWS
Checked by	
Project Name	JS
4TH FLOOR ACU AUTOMATIC DOOR OPERATORS	
Sheet Title	
INITIATING DEVICE RISER DIAGRAM LEVEL 4	
Date	07/06/2022
Scale	NONE

FA.2.08B



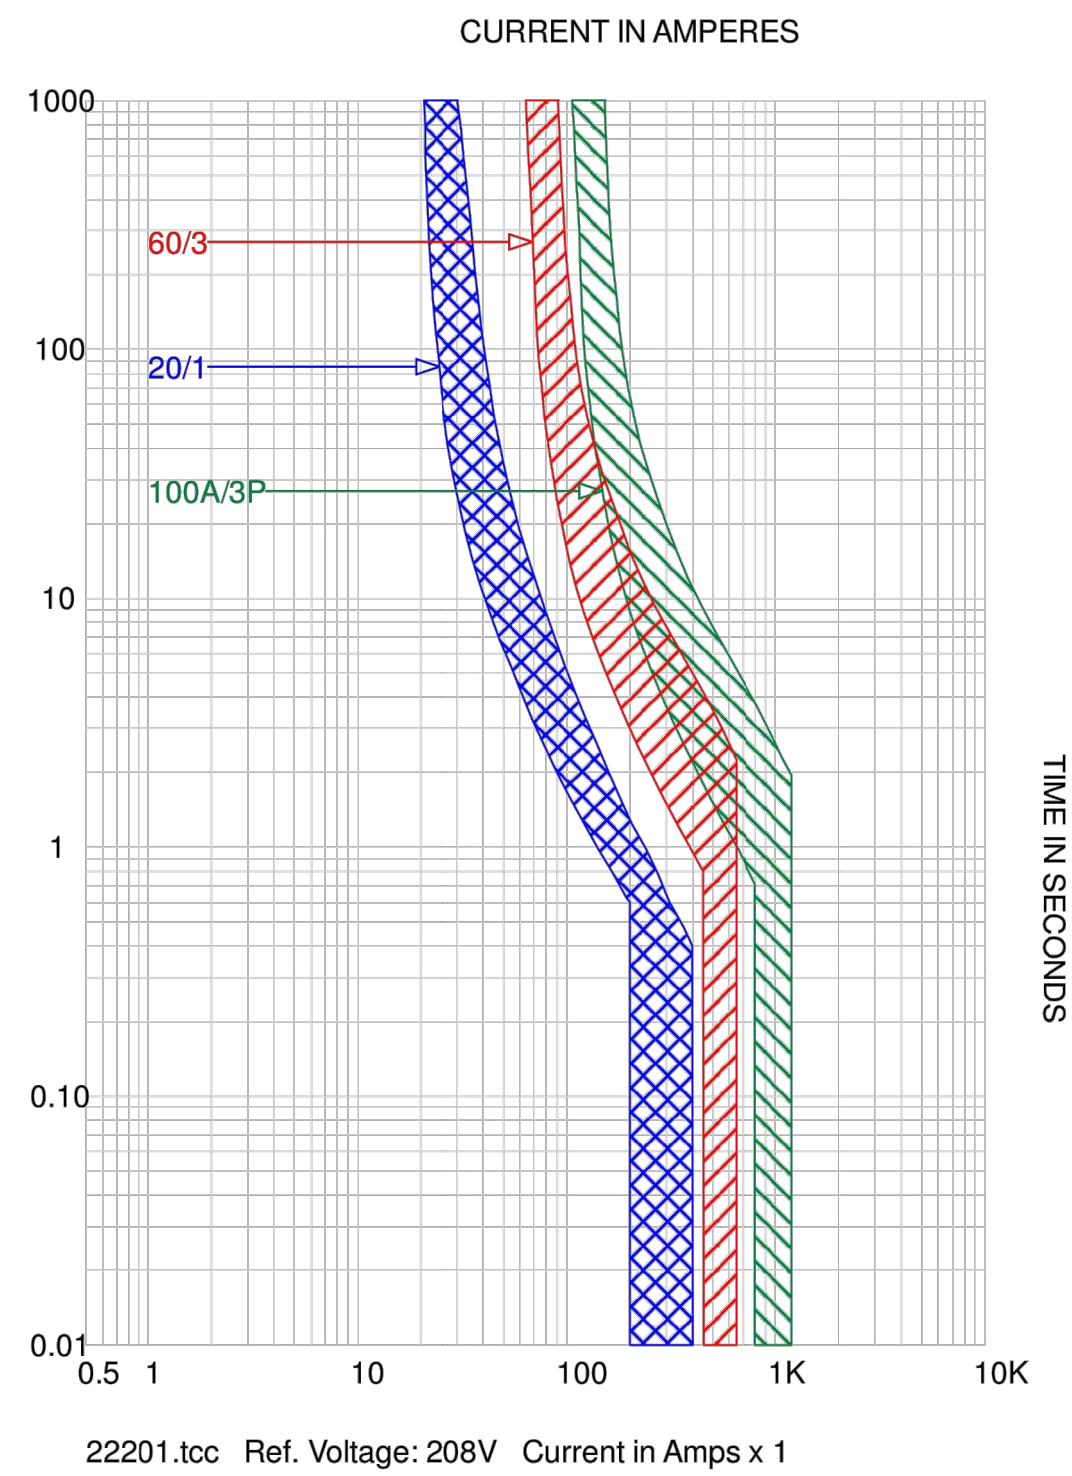
SEE SHEET FA.2.08A FOR CONTINUATION

INITIATING DEVICE RISER DIAGRAM

LEVEL 4

NOTE: ALL FIRE/SMOKE DAMPERS OPERATE VIA AREA SMOKE DETECTION.
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Sep 19, 2022 15:11:45 Page 1
Project Name: 22201
TCC Name: 22201.tcc
Reference Voltage: 208 V
Current Scale: X 10^0
TCC Notes:
TCC Comment:
Fault Duty Option: Study Result - Bus Fault Current

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Device Name: 60/3 TCC Name: 22201.tcc
Bus Name: PANEL LLD3G1 Bus Voltage: 208.0V
Function Name: Phase
Manufacturer: EATON/CUTLER-HAMMER
Description: 15-100A
Type: BAB, 3-Pole
AIC Rating: 10kA Fault Duty: 114205.7A
Frame: BAB 240V 60A Tcc Current Multiplier: 1
Tcc Time Multiplier: 1 Tcc Time Adder: 0s
Trip: 60A
Setting: 1) Fixed

Device Name: 20/1 TCC Name: 22201.tcc
Bus Name: PANEL LL4B1 Bus Voltage: 208.0V
Function Name: Phase
Manufacturer: EATON/CUTLER-HAMMER
Description: 10-70A
Type: BAB, 1-Pole
AIC Rating: 10kA Fault Duty: 15919.2A
Frame: BAB 240V 20A Tcc Current Multiplier: 1
Tcc Time Multiplier: 1 Tcc Time Adder: 0s
Trip: 20A
Setting: 1) Fixed

Device Name: 100A/3P TCC Name: 22201.tcc
Bus Name: PANEL LLD3G1 Bus Voltage: 208.0V
Function Name: Phase
Manufacturer: EATON/CUTLER-HAMMER
Description: 15-100A
Type: BAB, 3-Pole
AIC Rating: 10kA Fault Duty: 114205.7A
Frame: BAB 240V 100A Tcc Current Multiplier: 1
Tcc Time Multiplier: 1 Tcc Time Adder: 0s
Trip: 100A
Setting: 1) Fixed

COORDINATION STUDY
SCALE: NONE

1
E2.0

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Job No. 22201

SKA Project Number
2219
HCAI Number
S220544-38-00
HCAI seal/signature

Seal/Signature

Issued for
HCAI PLAN REVIEW
BACKCHECK #1 09/21/2022

Drawn by JS
Checked by RH
Project Name

4TH FLOOR ACU
AUTOMATIC DOOR
OPERATORS

Sheet Title
COORDINATION STUDY

Date 06/22/2022
Scale AS NOTED
Sheet Number

E2.0

30 X 42