


10/18/2018


DAB-2.

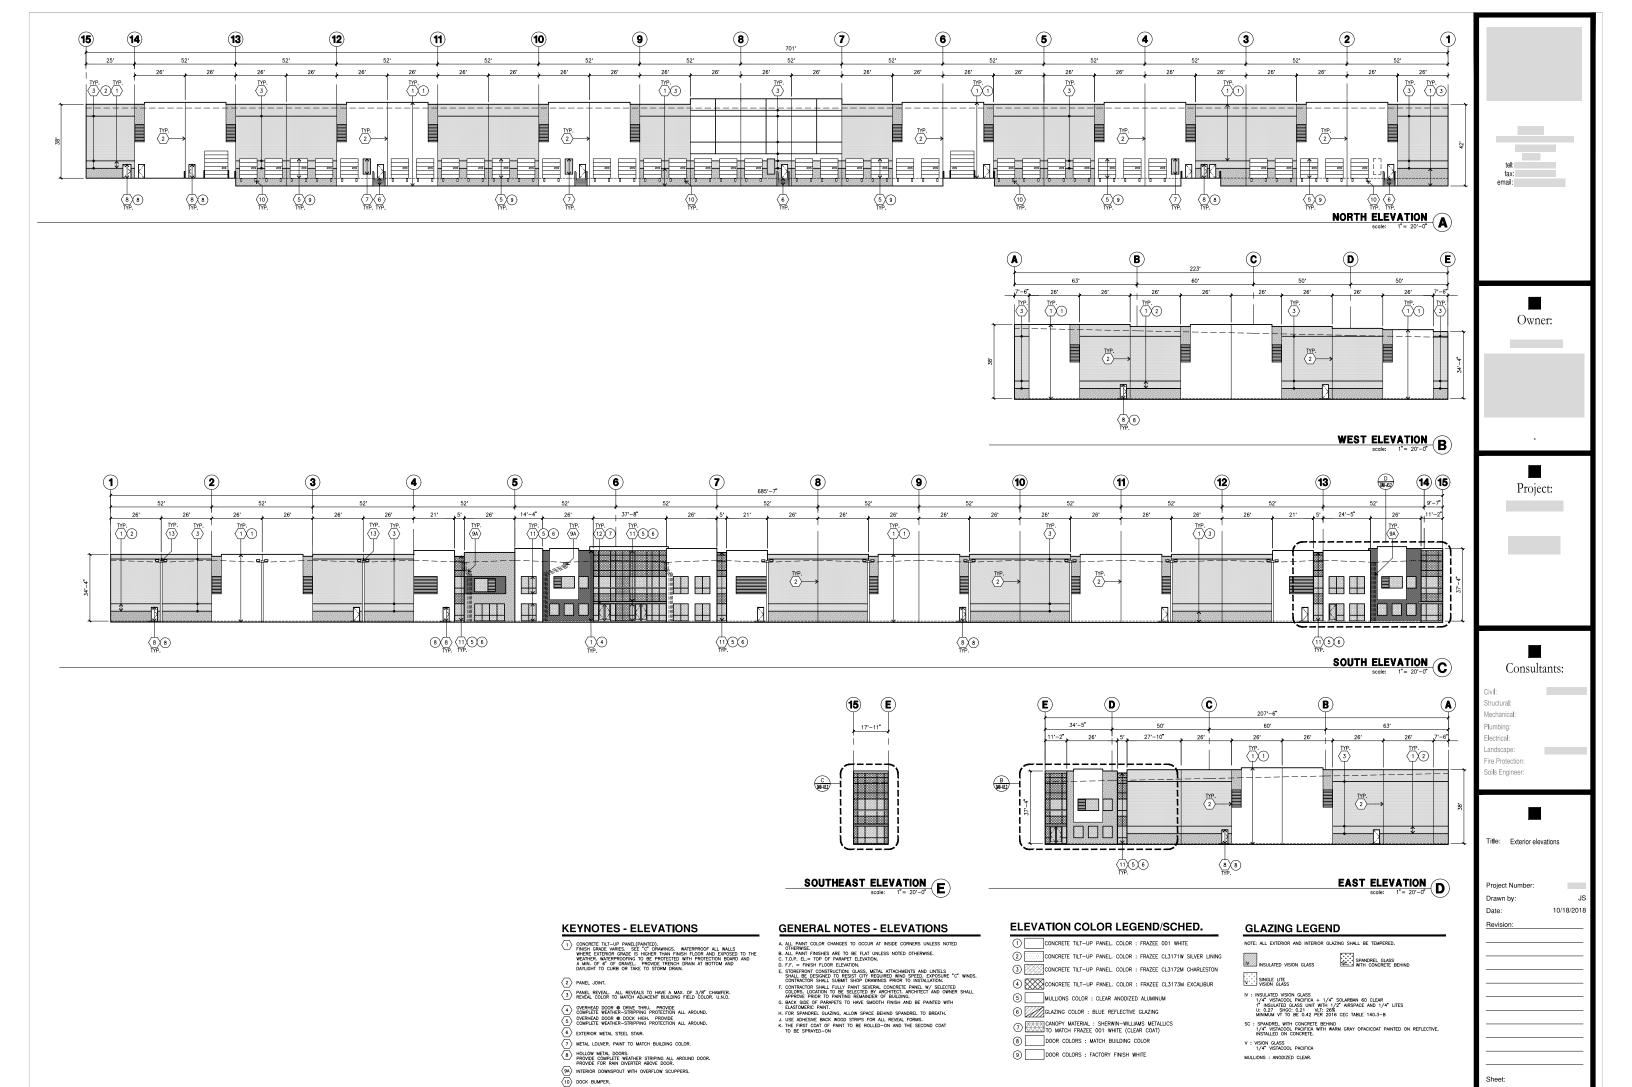



12 METAL TUBE STEEL CANOPY


13 EXTERIOR DOWN SPOUTS & 2 OVERFLOW SCUPPERS

DAB-3.1

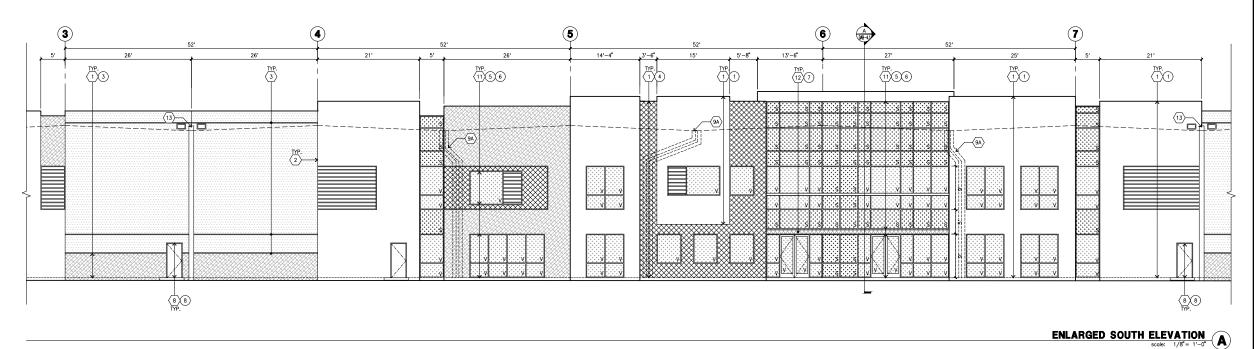

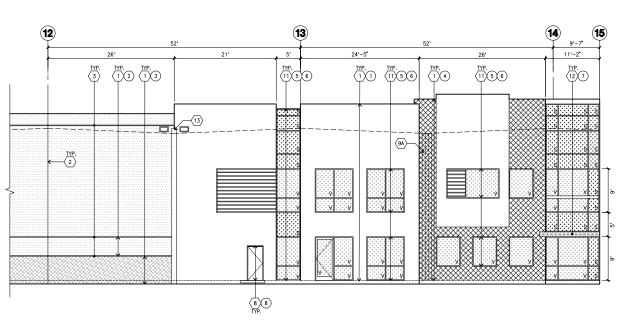

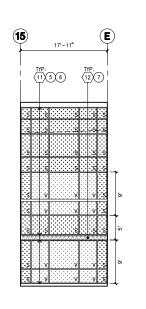

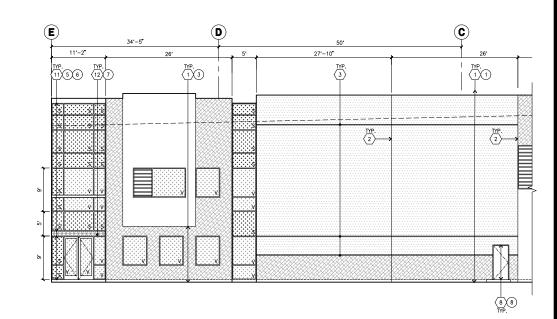

ENLARGED SOUTH ELEVATION Scale: 1/8"= 1'-0"

S-E ELEVATION scale: 1/8" = 1'-0"

ENLARGED EAST ELEVATION Scale: 1/8'= 1'-0'

KEYNO)TES - I	ELEVA	TIONS

- 2 PANEL JOINT.
- 3 PANEL REVEAL. ALL REVEALS TO HAVE A MAX. OF 3/8" CHAMFER. REVEAL COLOR TO MATCH ADJACENT BUILDING FIELD COLOR. U.N.O.
- OVERHEAD DOOR ® DRIVE THRU. PROVIDE COMPLETE WEATHER-STRIPPING PROTECTION ALL AROUND.
 OVERHEAD DOOR ® DOCK HIGH. PROVIDE COMPLETE WEATHER-STRIPPING PROTECTION ALL AROUND.
- 6 EXTERIOR METAL STEEL STAIR. 7 METAL LOUVER. PAINT TO MATCH BUILDING COLOR.
- B HOLLOW METAL DOORS.
 PROVIDE COMPLETE WEATHER STRIPING ALL AROUND DOOR.
 PROVIDE FOR RAIN DIVERTER ABOVE DOOR.
- PROVIDE FOR RAIN DIVERTER ABOVE DOOR.

 9A INTERIOR DOWNSPOUT WITH OVERFLOW SCUPPERS.

 10 DOCK BUMPER.
- 11) ALUMINUM STOREFRONT FRAMING WITH TEMPERED GLAZING.
- 12 METAL TUBE STEEL CANOPY
- 13 EXTERIOR DOWN SPOUTS & 2 OVERFLOW SCUPPERS

GENERAL NOTES - ELEVATIONS

- A LL PAINT COLOR CHANGES TO OCCUR AT INSIDE CORNERS UNLESS NOTED OTHERWISE.

 OTHERWISE.
 ALL PAINT FINISHES ARE TO BE FLAT UNLESS NOTED OTHERWISE.
 C. T.O.P. EL.= TOP OF PRARET ELEVATION.
 E.F. = FIRST FLOOR ELEVATION.
 E. SHALL FLOOR FLAVIORS. METAL ATTACHMENTS AND LINTELS.
 C. STATE OF THE PRARET SHALL PAINT SEVERAL CONSETT PAINEL WY SELECTED.
 F. CONTRACTOR SHALL SHULT SHAPT SEVERAL CONSETT PAINEL WY SELECTED.
 F. CONTRACTOR SHALL SHULT SHAPT SEVERAL CONSETT PAINEL WY SELECTED.
 AFFROVE PRIOR TO PAINTING ACTION OF DEANINGS FOR TO INSTALLATION OWNER SHALL MAY SEVERAL CONSETT PAINEL WY SELECTED.
 F. CONTRACTOR SHALL FLULY PAINT SEVERAL CONSETT PAINEL WY SELECTED.
 AFFROVE PRIOR TO PAINTING ALLOW SPACE BERNIOR OF POLINGIBL CONTRACTOR.
 C. BACK SIDE OF PRARPETS TO HAVE SMOOTH FINISH AND BE PAINTED WITH ELASTOMERIC PAINTING. ALLOW SPACE BERNIOR OF PAINFIEL TO SHAPE CONTRACTOR SHAPE OF THE SECOND COAT TO SHAPE OF THE PAINTING AND THE SECOND COAT TO SERVED.

 IN THE FIRST COAT OF PAINT TO BE ROLLED—ON AND THE SECOND COAT TO BE SPRAYED—ON

ELEVATION COLOR LEGEND/SCHED.

- 1 CONCRETE TILT-UP PANEL. COLOR : FRAZEE 001 WHITE CONCRETE TILT-UP PANEL. COLOR : FRAZEE CL3171W SILVER LINING 3 CONCRETE TILT-UP PANEL. COLOR : FRAZEE CL3172M CHARLESTON
- (4) CONCRETE TILT-UP PANEL. COLOR: FRAZEE CL3173M EXCALIBUR
- 5 MULLIONS COLOR : CLEAR ANODIZED ALUMINUM
- 6 GLAZING COLOR : BLUE REFLECTIVE GLAZING
- CANOPY MATERIAL : SHERWIN-WILLIAMS METALLICS TO MATCH FRAZEE 001 WHITE (CLEAR COAT)
- B DOOR COLORS : MATCH BUILDING COLOR
- 9 DOOR COLORS : FACTORY FINISH WHITE

GLAZING LEGEND

NOTE: ALL I	EXTERIOR AND	INTERIOR	GLAZING	SHALL	BE TEMPE	RED.	
INSUL	LATED VISION (GLASS	:	SP/	ANDREL GL	ASS TE BEHI	IN

- SINGLE LITE VISION GLASS
- V: INSULTATION USION CLASS
 1/4" ATLANTICA + 1/4" SUNCATE 400 CLEAR
 1 INSULTED CASSE UNIT WITH 1/2" ARSPACE AND 1/4" LITES
 1/4 ST STOCK 2.53 FT STOCK CLEAR
 MINIAUM VI TO BE 0.42" PER 2016 CEC TABLE 140.3—B
- SC: SPANDREL WITH CONCRETE BEHIND

 1/4" CLEAR WITH ATLANTIC WATERS OPACICOAT PAINTED ON REFLECTIVE.
 INSTALLED ON CONCRETE. V : VISION GLASS 1/4" ATLANTICA

tel: fax: email:

Owner:

Project:

Consultants:


Electrical:

.andscape: Fire Protection: Soils Engineer:

Title: Enlarged exterior elevations

Drawn by: 10/18/2018 Date: Revision:

DAB-3.2

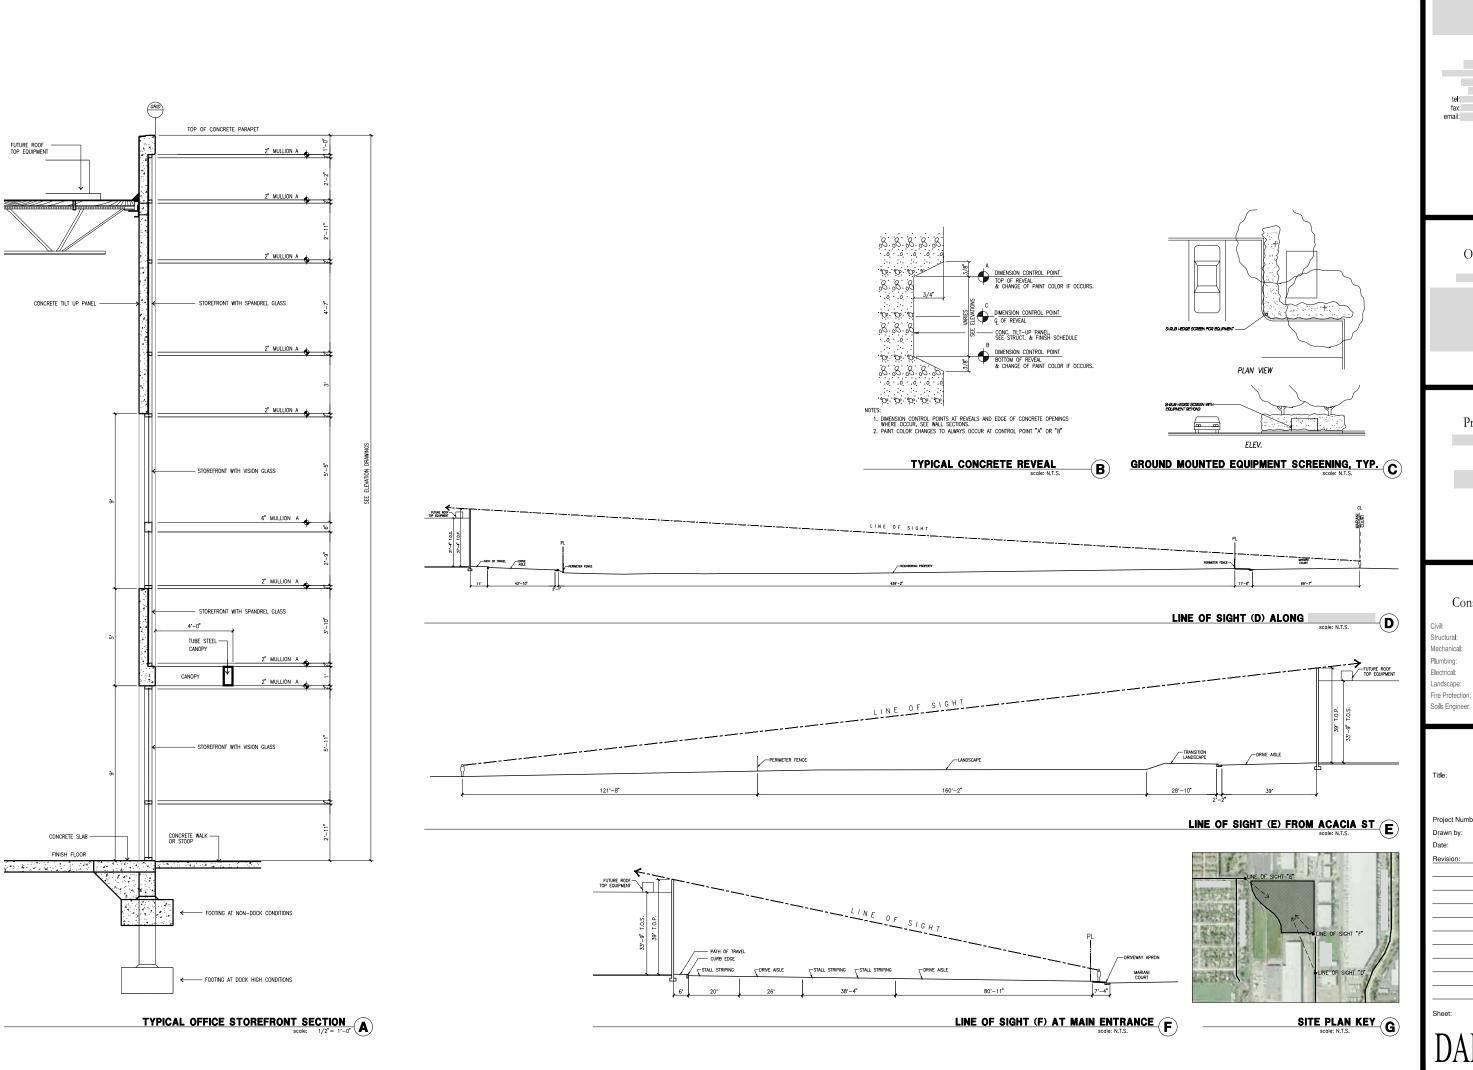

Owner:

Project:


Consultants:

Landscape: Fire Protection:

Detai**l**s

10/18/2018

DAB-4.1

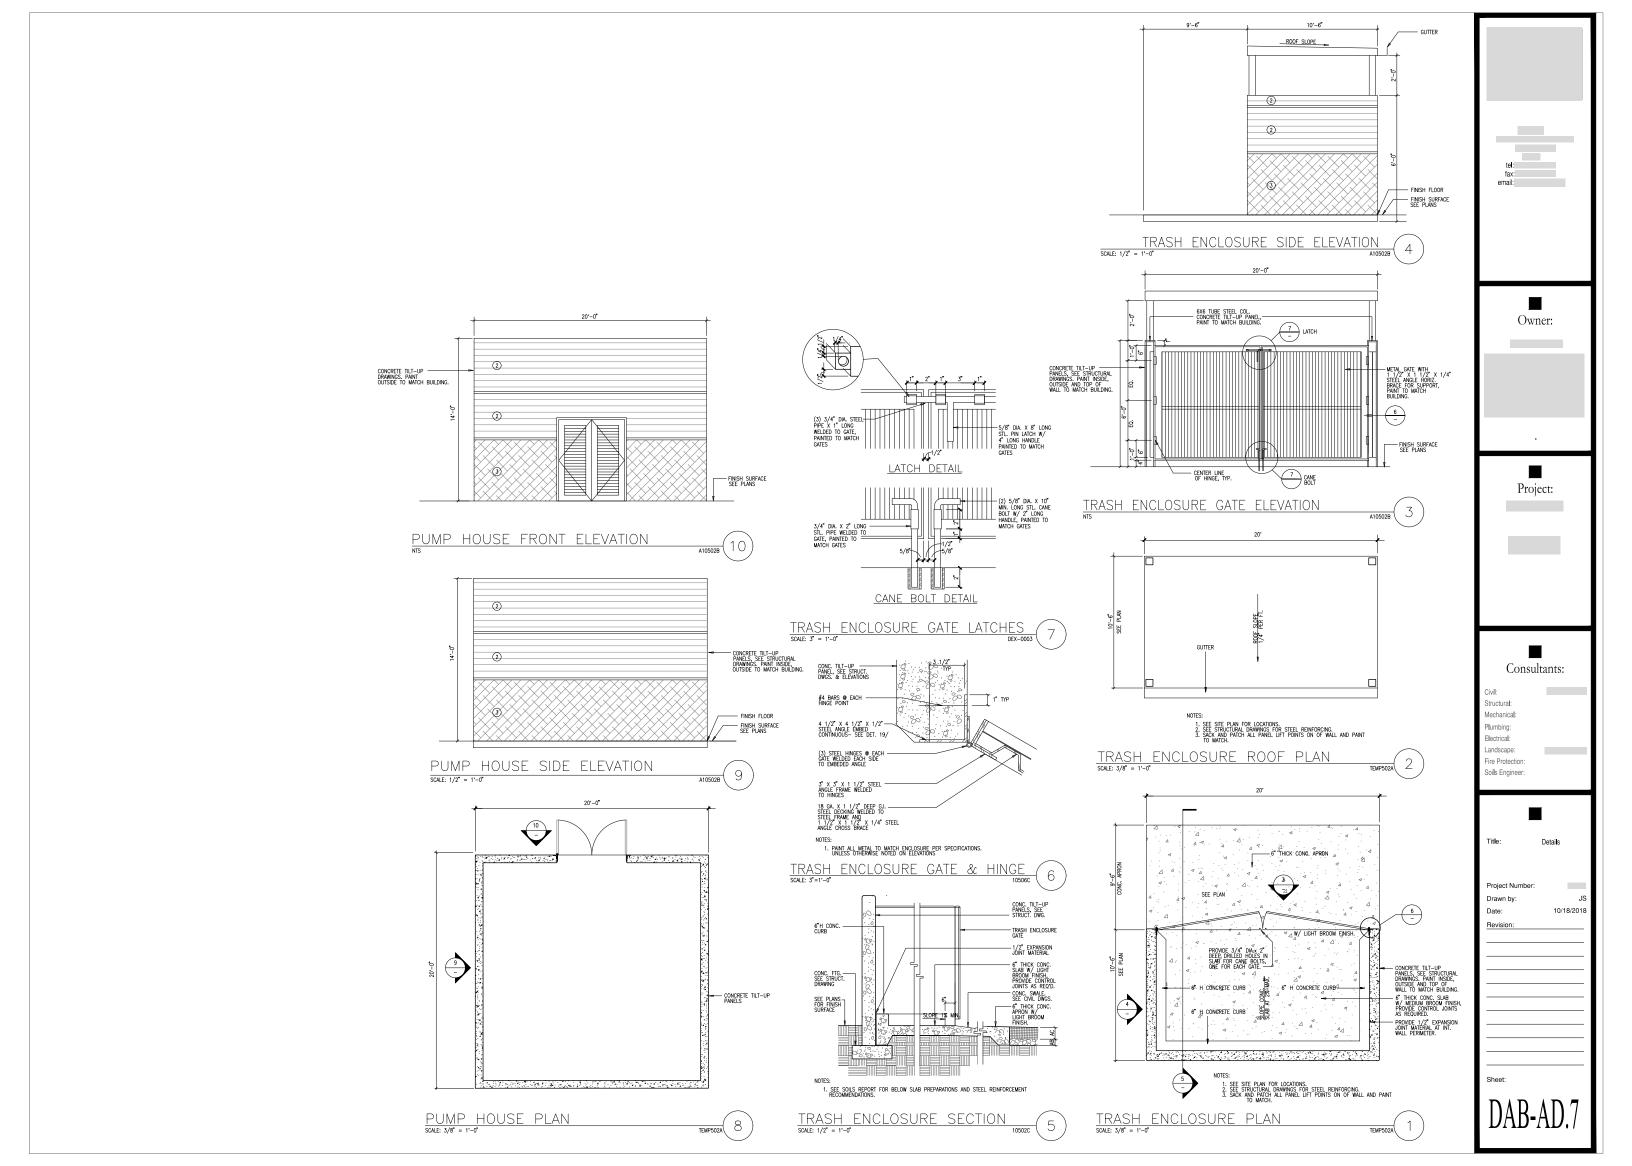

NOTE: CONTRACTOR SHALL CONTACT GOVERNING AGENCY TO OBTAIN REQUIRED INFORMATION SAFETY NOTES
FOR THE PROPER OPERATION AND
MAINTENANCE OF THE WROUGHT IRON GATES THIS GATE IS UNSAFE FOR OPERATIONS IN HEAVY WIND LOADS 15 MPH OR GREATER. AND SHALL COMPLETE SIGN TEXT. GREAIER.

2. GATE CAN NOT BE OPERATED IN IN WINDS IN EXCESS OF 15 MPH.

3. GATE NEEDS TO BE LOCKED IN EITHER THE OPEN OR CLOSED POSITION AT ALL TIMES. NO SCREENING OF ANY KIND IS ALLOWED ON THE GATE. 5. ALL GATES TO BE MECHANICALLY OPERATED . GATE OPERATOR IS RESPONSIBLE FOR THE SAFETY OF PEOPLE AND PROPERT Notes:

1. Min. 1" High text.

Signs shall be permanently affixed reflectorized sign of porcelain on steel with beaded text or equal mounted at a Height of 60" above finished grade, to top 0° sign.

2. Signage shall conform to Sec. 4.30 of the Americans with disabilities act.

3. This sign is to be posted on the exterior side of each gate or pair of gates. METAL GATE SAFETY SIGN 02890-SGATE-SIGN1 (4) -2" x 4" MIN. STEEL OPTIONAL TUBE HORIZONTAL SUPPORT LEVER HANDLE OR -1" SQUARE VERTICAL MIN. MEMBERS @ 8" O.C. TYP. - CAUTION SIGN PROVIDE A 10" KICK PLATE — LOCATED ON THE PUSH SIDE OF THE GATE 1. SAND AND GRIND ALL WELDS SMOOTH.
PRIME AND PAINT TO BLACK.
2. SEE SCREEN WALL ELEVATION FOR HEIGHT.
3. EXTERIOR CATES SHALL BE ABLE TO HAVE BUS PAD LOCK FIRE DEFARMENT PAD LOCK. METAL GATE
SCALE: 1/2" = 1'-0" (3) NOTE: CONTRACTOR SHALL CONTACT GOVERNING AGENCY TO OBTAIN REQUIRED INFORMATION AND SHALL COMPLETE SIGN TEXT. -#4 @ 24" O.C. -1 1/2" X 1 1/2" ANGLE W/ NELSON ANCOR BOLTS @ 24" O.C. & 6" FROM ENDS. #4 CONT. EA. SIDE WITH #4 BARS . 15" LONG @ 24" O.C. USE OF GATE UNDER WINDY CONDITIONS IS PROHIBITED LEAVE GATE LOCKED OPEN OR LOCKED CLOSED 1. SIGNS SHALL BE PERMANENTLY AFFIXED REFLECTORIZED SIGN OF PORCELAIN ON STEEL WITH BEADED TEXT OR EAQUAL MOUNTED AT A HEIGHT OF 60° ABOVE FINISHED GRADE, TO 10P OF SIGN.

2. SINAGE SHALL CONFORM TO SEC. 4.30 OF THE AMERICANS WITH DISABILITIES ACT.

3. THIS SIGN IS TO BE POSTED ON THE EXTERIOR SIDE OF EACH GATE OR PAIR OF GATES. NOTES:

1. TRACK AND CHANNEL TO BE GALVANIZED. GATE TRACK @ DRIVE SINGLE SLIDING SOLE 1' = 1'-0' Soils Engineer: W.I. GATE SAFETY SIGN 02890-SGATE-SIGN2 (6) WROUGHT IRON FENCE BEYOND 3/16" (TYP. 1'-6" (L ___4" X 4" X 1/4" TUBE STEEL, CAC PAVING PER CIVIL PLANS -ROLLER ASSEMBLY (TOP & BOTTOM) -1" X 1" X 14GA PICKETS @ 8" O.C. -2500 PSI CONCRETE FOOTING NOTES: 1. GATE CONTRACTOR TO PROVIDE ENGINEERING AND DETAILING FOR GATE TO WITHSTAND 90 MPH, EXPOSURE "C" WIND FORCES. ARCHITECT TO APROVE SHOP DRAWINGS PRIOR TO INSTALATION.

ROLLING GATE W/ FENCE

SCALE: 1 1/2" = 1"-0" FOR STEEL TUBE
FOOTING, SEE DETAIL 8/AD.5 _4" X 4" X 1/4" TUBE STEEL, GATE FOOTING @ FENCE CONDITION 5

Owner:

Project:

Consultants:

Structural: Mechanical: Plumbing:

Electrical: Landscape: Fire Protection:

Detai**l**s

Drawn by: Date:

10/18/2018

Sheet:

DAB-AD.8